

SITE PLAN APPROVAL APPLICATION

| 3290012 HOVA SCOT | 'i.A. |
|---|--|
| Date: 25/3/17 Applicant: MIKE HEBB & JASON KI | BAT'ING OFFICE USE ONLY: |
| Mailing Address: PO BOX 117 HALIFAX B3J | 5 2 L 4 Application #: SP-005-2025 |
| Email: JKELTINK eGRIFFIN-ES. COM Phone: 907 | 2 488 · 8287 Fee: Date Paid: |
| Project Location: PiD 55499602 /FROM | T STUBET Approved by: |
| Project Details: HEW CONSTRUCTION | Date Approved: |
| PID: 5549960Z | Appeal Hearing Received: Date: |
| This application must be accompanied by plans prepared by a qualifie | Appeal Decision: |
| e. engineer, architect, landscape architect, surveyor, etc.) as describe | ed in part 2.10 of LRO Registration #: |
| the Land Use Bylaw. The plans are to be based on the best available a mapping or aerial images and include the following: | and most current Registration Date: |
| Topographical Survey (no more than 5 years old) reflecting existing | Servicing Schematic including the following: |
| topographic and boundary conditions | sewer lateral locations including size. |
| | water lateral locations including size. |
| Site Plan and Conceptual Grading Plan which includes the following: | existing trunk services that will service the property. |
| a key plan, property identification (PID#, lot number, and/or civic number) and name of property owner. | Architectural Plans which include the following: |
| footprint and area of proposed buildings, setbacks from all property boundaries and location of any existing building or structures to be retained or demolished. | streetwall height and setbacks pursuant to each zone. building elevations and articulation on all sides including signage and lighting. |
| driveway locations and surface parking area. landscaping, including fences, walls, stormwater features, | notes on building material intentions. |
| landscape beds, trees, etc. | floor plans for every level. perspective rendering of the building or 3D Sketchup model. |
| Any other information deemed necessary by the Development | |
| Officer to determine compliance with the zone requirements. | Traffic Impact Study (for buildings over 8 units or 1200 square metres). |
| certify that I am submitting this application, including all of the required support | rting information, for approval with the consent of the owner(s) of the subject |
| | |

Applicant Signature

March 17, 2025

Date



IMAGE IS FOR REFERENCE ONLY. CONSTRUCTION SHALL BE AS PER TECHNICAL DRAWINGS THAT FOLLOW





PROJECT DESCRIPTION:

NEW DEVELOPMENT BLEND OF COMMERCIAL & RESIDENTIAL SPACES IN THE HEART OF WOLFVILLE. GROUND FLOOR LEVEL OFFERS TWO SEPARATE COMMERCIAL SPACES FOR MERCANTILE AND/OR BUSINESS/PERSONAL SERVICES WHILE THE SECOND LEVEL OFFERS FOUR SEPARATE DWELLING UNITS WITH EACH CONTAINING A BEDROOM ON AN ADDITIONAL LEVEL. BEDROOMS ARE LOCATED ON A THIRD LEVEL MEZZANINE STYLE FLOOR LAYOUT OVERLOOKING THE MAIN LIVING AREA WITH VIEWS OUT A LARGE WINDOW PROVIDING MUCH NEEDED NATURAL SUNLIGHT AND CONNECTION TO THE OUTSIDE WORLD. ACCOMODATIONS FOR IN-HOME LAUNDRY HAVE BEEN STRATEGICALLY ADDED TO EACH UNIT AND LOCATED OFF A GENEROUS SECTION OF WALK-IN CLOSET, NEATLY TUCKED BEHIND EACH BEDROOM. THE CONNECTION OF ALL SPACES GRASPS A FREE FLOWING FEEL OF OPENNESS AND COMFORT LENDING PEACE OF MIND THROUGHOUT AS THERE IS "ROOM TO BREATHE".


THE EXTERIOR OF THE PROPERTY OFFERS LEASEABLE PARKING SPACES AT IT'S REAR AND INCLUDES CAR CHARGING SERVICES TO THOSE WITH ELECTRIC VEHICLES. THERE IS ALSO DIRECT ACCESS BY STAIRS AND A DECK AT THE REAR ABUTTING PROPERTY, TO OTHER COMMERCIAL SPACES ON MAIN STREET AS WELL AS A FOOD TRUCK. REAR ABUTTING PROPERTY CURRENTLY HAS CONNECTING ELECTRICAL SERVICES UNDERGROUND AND WILL CONTINUE TO BE UNDERGROUND FOR THIS NEW BUILDING, WITH NECESSARY MODIFICATIONS TO INCLUDE CONNECTIONS FOR THIS PROJECT.

| SHEET NUMBER | SHEET NAME | REVISION | REVISION DATE | | | | | |
|----------------------|--|----------|---------------|--|--|--|--|--|
| -COVER PAG | i BE | | | | | | | |
| A-00 | COVER PAGE | | | | | | | |
| 001 - SITE PL | ANS | | | | | | | |
| A-00 I | SITE PLAN | | | | | | | |
| 200 - FLOOR | PLANS (NEW) | l | | | | | | |
| A-200 | FLOOR PLAN - FOUNDATION | | | | | | | |
| A-201 | FLOOR PLAN - GROUND LEVEL | | | | | | | |
| A-202 | FLOOR PLAN - SECOND LEVEL | | | | | | | |
| A-203 | FLOOR PLAN - MEZZANINE LEVEL | | | | | | | |
| A-204 | ROOF PLAN | | | | | | | |
| A-205 | ELECTRICAL \$ CEILING PLAN - GROUND LEVEL | | | | | | | |
| A-206 | ELECTRICAL PLAN - SECOND LEVEL | | | | | | | |
| A-207 | ELECTRICAL PLAN - MEZZANINE LEVEL | | | | | | | |
| A-208 | REFLECTED CEILING PLAN - SECOND LEVEL | | | | | | | |
| A-209 | REFLECTED CEILING PLAN - MEZZANINE LEVEL | | | | | | | |
| A-210 | FLOOR FRAMING - SECOND LEVEL | | | | | | | |
| A-211 | FLOOR FRAMING - MEZZANINE LEVEL | | | | | | | |
| A-212 | -212 FLOOR FRAMING - ROOF LEVEL | | | | | | | |
| 300 - ELEVA | <u>FIONS</u> | | | | | | | |
| A-300 | BUILDING ELEVATIONS - NORTH / SOUTH | | | | | | | |
| A-301 | BUILDING ELEVATIONS - EAST / WEST | | | | | | | |
| A-302 | INTERIOR ELEVATIONS & PLAN - KITCHEN | | | | | | | |
| A-303 | INTERIOR ELEVATION & PLAN - STUDIO APT | | | | | | | |
| A-304 | INTERIOR ELEVATIONS & PLAN - BATHROOM | | | | | | | |
| <u>400 - BUILDII</u> | NG SECTIONS | | | | | | | |
| A-400 | BUILDING ELEVATIONS - SITE SECTION - EAST VIEW | | | | | | | |
| A-401 | BUILDING SECTION - EAST VIEWS | | | | | | | |
| A-402 | BUILDING SECTION - SOUTH VIEW | | | | | | | |
| A-403 | BUILDING SECTIONS - GROUND LEVEL | | | | | | | |
| 600 - SECTIO | N DETAILS | | | | | | | |
| A-600 | ASSEMBLY DETAILS | | | | | | | |
| A-60 I | CONSTRUCTION DETAILS | | | | | | | |
| A-602 | CONSTRUCTION DETAILS | | | | | | | |
| A-603 | CONSTRUCTION DETAILS | | | | | | | |
| A-604 | STAIRS, GUARDS, & RAILINGS DETAILS | | | | | | | |
| 700 - SCHED | <u>ULES</u> | | | | | | | |
| A-700 | DOOR SCHEDULES | | | | | | | |
| A-701 | WINDOW SCHEDULE | | | | | | | |
| TOTAL PAGE | ES: 31 | | | | | | | |

| EM | 2015 NATIONAL E | BUILDING CODE O | F CANADA | | | | N.B.C. REFERENCE |
|-----|--------------------------------|--|---|------------------------------------|------------------------------|-------------------------|---|
| | | | | | | | |
| .0 | PROJECT DESCRIPTION: | NEW □ ADDITION □ ALTERATION □ CHANGE OF | | □PART 3 □PART 9 | | | Division A Part I .3.3.3 |
| 2.0 | MAJOR OCCUPANCY: | GROUP - DORE C = SE | | GROUND LE | | | 3.1.2.1 Table 3.1.2.1 |
| 3.0 | BUILDING AREA: | TOTAL: 216.5m² | | | | | |
| 4.0 | GROSS AREA: | 216.5r | n ² = GROU n ² = SECOI n ² = THIRD | ND LEVEL | | <u>TAL</u> .5m² | |
| 5.0 | No. OF STOREYS: | <u> </u> | | | | | |
| 5.0 | MEZZANINE(S): | YES (CONSIDERI | ED A STOR | EY) | | | |
| 7.0 | INTERCONNECTED FLOOR SPACES | | | | | | |
| 3.0 | HEIGHT: | 3 STOREYS | | | | | |
| 9.0 | No. OF STREETS & ACCESS ROUTES | 1 | | | | | |
| 0.0 | BUILDING CLASSIFICATION: | PART 9 | | | | | 3.1.2.1 Table 3.1.2.1 |
| 1.0 | SPRINKLER SYSTEM | ☐ ENTIRE BUIL ☐ ADDITION O ☐ BASEMENT | NLY | □IN LIEU OF ⊠NOT REQL | | NG | |
| 2.0 | STANDPIPE | ☐ REQUIRED ☐ SUPPLY IS A | | □NOT REQU | | JATE | |
| | SYSTEM: | ☐ REQUIRED | | ⊠NOT REQL | IIRED | | |
| | FIRE ALARM: | □YES | | 9.10.18.2 | | | |
| 4.0 | OCCUPANT LOAD: | PERSONS COMMERCIAL = APARTMENTS = | 32 | Øboile | ING DESIGN | | 3.1.17.1. TABLE 3.1.17.1. |
| 5.0 | FIXTURES | LEVEL OCCULOAD BASEMENT - GROUND - | | | VERSAL PROVIDED | | 9.31.1.1.(2) 3.7.2.(04),(12) 3.8 |
| | | FIRST - TOTAL W.C. PRO ROUGH-IN WATE | | | | | |
| 6.0 | BARRIER-FREE DESIGN | ☐ YES GROUND FLOOF FLOOR AREAS | | □NO CIAL ARE ON | ILY ACCESS | IBLE | NOTE: NOVA SCOTIA BUILDING CODE FOLLOWED |
| 7.0 | FIRE RESISTANCE | FIRE RESISTANCE FLOORS: | ERATING | | RATING 45 MIN. | | 9.10.8.1 |
| | RATINGS: | MEZZ: ROOF: | | | 45 MIN. | | 9.10.8.1 9.10.14.5-A |
| | | FIRE SEPARATION SUPPORTING ST. ASSEMBLIES SU | RUCTURE S. | | 2 HOUR | | 9.10.8.1 9.10.9.11.(2) 9.10.8.3 |
| | | | | | | | |
| | | | | | | | |
| 8.0 | SPATIAL SEPARATIONS: | WALL AREA (m | , I | PERMITTED MAX. % OF OPENINGS | MAX% OF | F.R.R. (HRS) | 9.10.14.4.(b) 9.10.14.5-A 3.2.3.1.B |
| 8.0 | | NORTH | (M) H/l | MAX. % OF OPENINGS | MAX% OF OPENINGS ≤100% | 1 | 9.10.14.5-A |
| 8.0 | | NORTH SOUTH | 9m 7.6m | MAX. % OF OPENINGS 100% | MAX% OF OPENINGS ≤100% ≤100% | (HRS) 1HR/45MIN 45MIN | 9.10.14.5-A |
| 8.0 | | NORTH | (M) H/l | MAX. % OF OPENINGS | MAX% OF OPENINGS ≤100% | (HRS) 1HR/45MIN | 9.10.14.5-A |

BUILDING CODE.

| ABBREVI | ATION LEGEND: | | |
|----------------|----------------------------------|--------|---------------------------|
| A.F.F. | ABOVE FINISHED FLOOR | No. | NUMBER |
| В.О. | воттом оғ | O.C. | ON CENTER |
| CL.HT. | CEILING HEIGHT | OSB | ORIENTED STRAND BOARD |
| DIA. | DIAMETER | OWJ | OPEN WEB JOIST |
| DP. | DEPTH | P.T. | PRESSURE TREATED |
| EQ. | EQUAL | PSL | PARALLEL STRAND LUMBER |
| EXT. | EXTERIOR | QTY | QUANTITY |
| F.P.R. | FIRE PROTECTION RATING | R.O. | ROUGH OPENING |
| F.R.R. | FIRE RESISTANCE RATING | S.I.P. | STRUCTURAL INSULATED PANE |
| GA. | GAUGE | SF | SQUARE FEET |
| GLULAM | GLUED-LAMINATED LUMBER | SPF | SPRUCE PINE FIR |
| HT. | HEIGHT | STC | SOUND TRANSMISSION CLASS |
| L. | LENGTH | T#G | TONGUE & GROOVE |
| LSL | LAMINATED STRAND LUMBER | T.B.D. | TO BE DETERMINED |
| LVL | LAMINATED VEENER LUMBER | T.O. | TOP OF |
| M ² | SQUARE METER | TJI | TRUS JOIST I-JOIST |
| M.O. | MASONRY OPENING | U/S | UNDERSIDE |
| MAX. | MAXIMUM | U.N.O | UNLESS NOTED OTHERWISE |
| MIN. | MINIMUM | W/ | WITH |
| N.B.C. | NATIONAL BUILDING CODE OF CANADA | W. | WIDTH |
| N.I.C. | NOT IN CONTRACT | | |

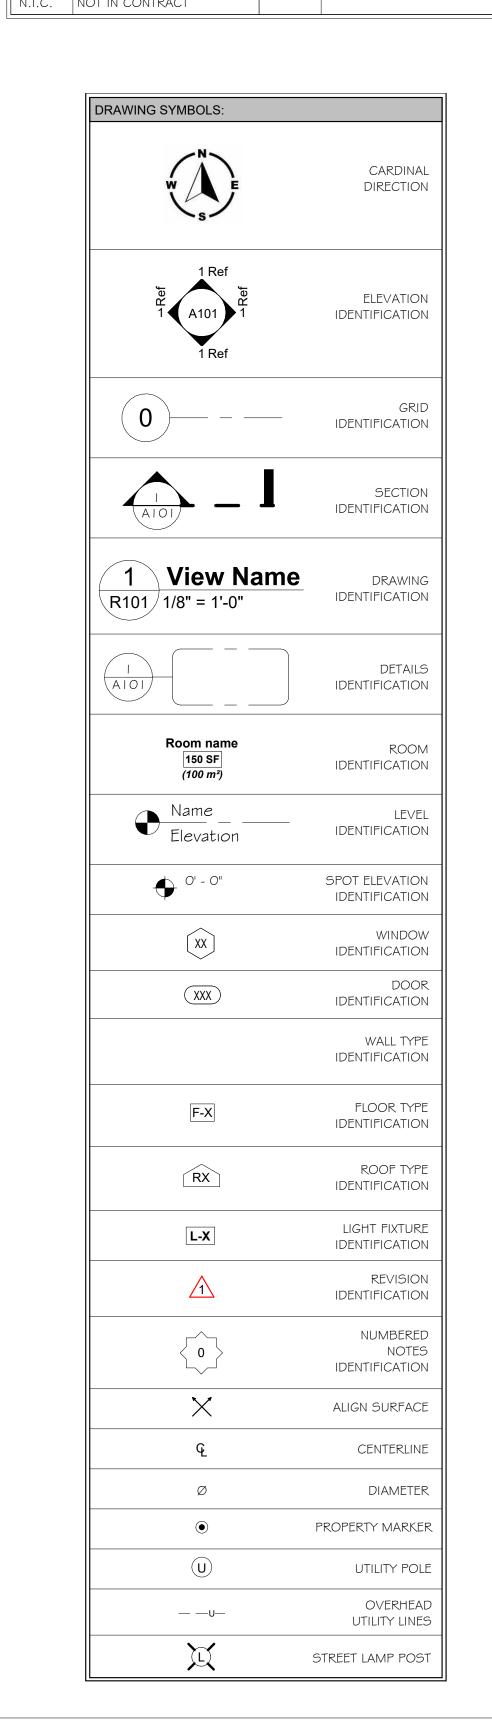

GENERAL NOTES:

- 1. CONTRACTOR MUST VERIFY ALL DRAWINGS WITH ON SITE CONDITIONS REPORTING ANY DISCREPANCIES TO ARCHITECT BEFORE PROCEEDING W/ WORK.
- 2. ANY DISCREPANCIES FOUND IN DRAWINGS SHOULD BE REPORTED TO THE ARCHITECT IMMEDIATELY BEFORE PROCEEDING FURTHER WITH THE WORK.
- 3. DRAWINGS ARE NOT TO BE USED FOR CONSTRUCTION UNTIL SIGNED BY THE ARCHITECT.

OF THE AUTHORITY HAVING JURISDICTION.

- 4. DO NOT SCALE FROM THE DRAWINGS. ALL WORK IS TO CONFORM TO THE NATIONAL BUILDING CODE
- OF CANADA AND ALL APPLICABLE LOCAL CODES AND BY-LAWS. 6. ALL WORK SHALL BE PERFORMED IN ACCORDANCE WITH THE LABOUR AND HEALTH AND SAFETY LAWS AND REGULATIONS

| | ISSUED FOR PERMIT | | 03-17-2025 |
|--|--|----------------------|------------------|
| Revision | Description | | Date Issued |
| | | I | |
| | ARCHITECT'S STAMP | OTHER CON | ISULTANT'S STAMP |
| 100 | Vincent den Hartog WARCH IT 2025 SOCIATION OF ARCHE | | |
| Project: | FRONT S APARTMI 456 MAIN S WOLFVILLE, PID: 55279 | ENTS STREET NS | T |
| Phase: Project Project Date : | Construction #: Pocuments 55499602 2025-03-17 | | |
| Client: | MIKE HEBB KEATING | & JASC | ON |

456 MAIN ST., WOLFVILE, NS B4P 1E2

Vincent den Hartog

Email:info@denhartogarchitect.com Website:www.denhartogarchitect.com

176 Main Street, Wolfville, Nova Scotia, B4P 1C1

COVER PAGE

Scale: As indicated

Checked By: VDH

Drawn By: DS

Architecture for rural communities

Architect

Tel: 902 542-4194

©2025 VINCENT DEN HARTOG, ARCHITECT THESE DRAWINGS ARE INSTRUMENTS OF DESIGN SERVICE FOR THE CONSTRUCTION OF THE PROJECT NAMED HEREIN. ANY OTHER UNAUTHORIZED USE OF THESE DOCUMENTS IS STRICTLY PROHIBITED




SITE PLAN - EXISTING

A-001 1 : 200



A-001 1 : 200

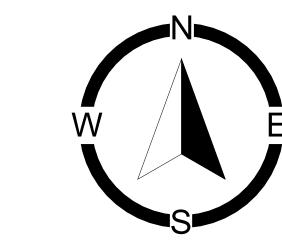

WOLFVILLE LAND USE BYLAWS NOTES:

" C-1 " ZONING REQUIREMENTS:

LOT AREA (MINIMUM) = $185m^2$ LOT COVERAGE = UP TO 100% BUILDING HEIGHT (MAXIMUM) = 3 STOREY

LOT FRONTAGE (MINIMUM) = 8mFRONT YARD SETBACKS = 0-4m FOR NO LESS THAN 85% OF THE BUILDINGS FRONTAGE FLANKAGE YARD SETBACK = 0-3m MIN. | SIDE YARD SETBACKS = Om (TO COMMERCIAL), OR

= 3m MIN. ABUTTING RESIDENTIAL,

INSTITUTIONAL, OR PARK REAR SETBACK = Om (TO COMMERCIAL), OR = 3m MIN. ABUTTING RESIDENTIAL,

MINIMUM GROUND FLOOR HEIGHT = 4m-PROPERTY BOUNDARY OUTLINE, ALONG WITH CARDINAL DIRECTIONS, LENGTHS, \$ SPOT ELEVATIONS ARE APPROXIMATED AND REQUIRE FURTHER VALIDATION FROM QUALIFIED SURVEY COMPANY


INSTITUTIONAL, OR PARK


| SYMBOL | LEGEND: | | | | |
|----------------------|--|--|--|--|--|
| \parallel \times | ALIGN SURFACE | | | | |
| | ELEVATION MARKER | | | | |
| Ģ. | CENTERLINE | | | | |
| Ø | DIAMETER | | | | |
| • | PROPERTY MARKER | | | | |
| Û | UTILITY POLE | | | | |
| Ä | STREET LAMP POST | | | | |
| | UNDERGROUND ELECTRICAL LINE | | | | |
| — —U— | OVERHEAD UTILITY LINES | | | | |
| | UNDERGROUND ELECTRICAL LINE(S) | | | | |
| | EV CHARGE STATION (WALLBOX, 208/240V) | | | | |

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FRONT STREET APARTMENTS

456 MAIN STREET WOLFVILLE, NS PID: 55279087

Phase: Construction Documents

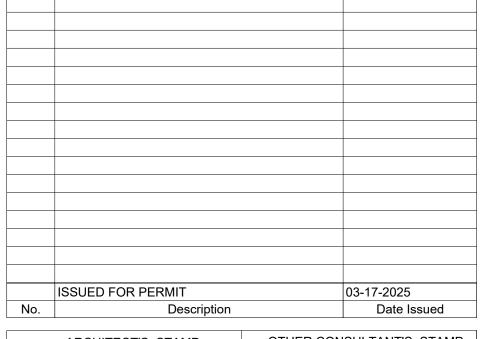Project #: 2023-389-01 Project PID: 55499602 Date: 2025-03-17

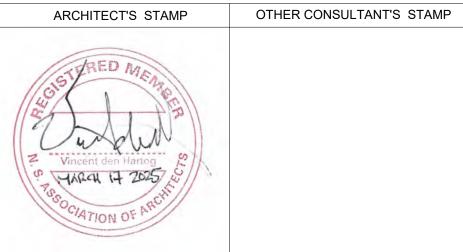MIKE HEBB & JASON KEATING

456 MAIN ST., WOLFVILE, NS B4P 1E2



Architecture for rural communities


Vincent den Hartog Architect

176 Main Street, Wolfville, Nova Scotia, B4P 1C1 Email:info@denhartogarchitect.com Website:www.denhartogarchitect.com

Sheet Title: SITE PLAN

Scale: As indicated Drawn By: Author Checked By: ∨DH

Tel: 902 542-4194

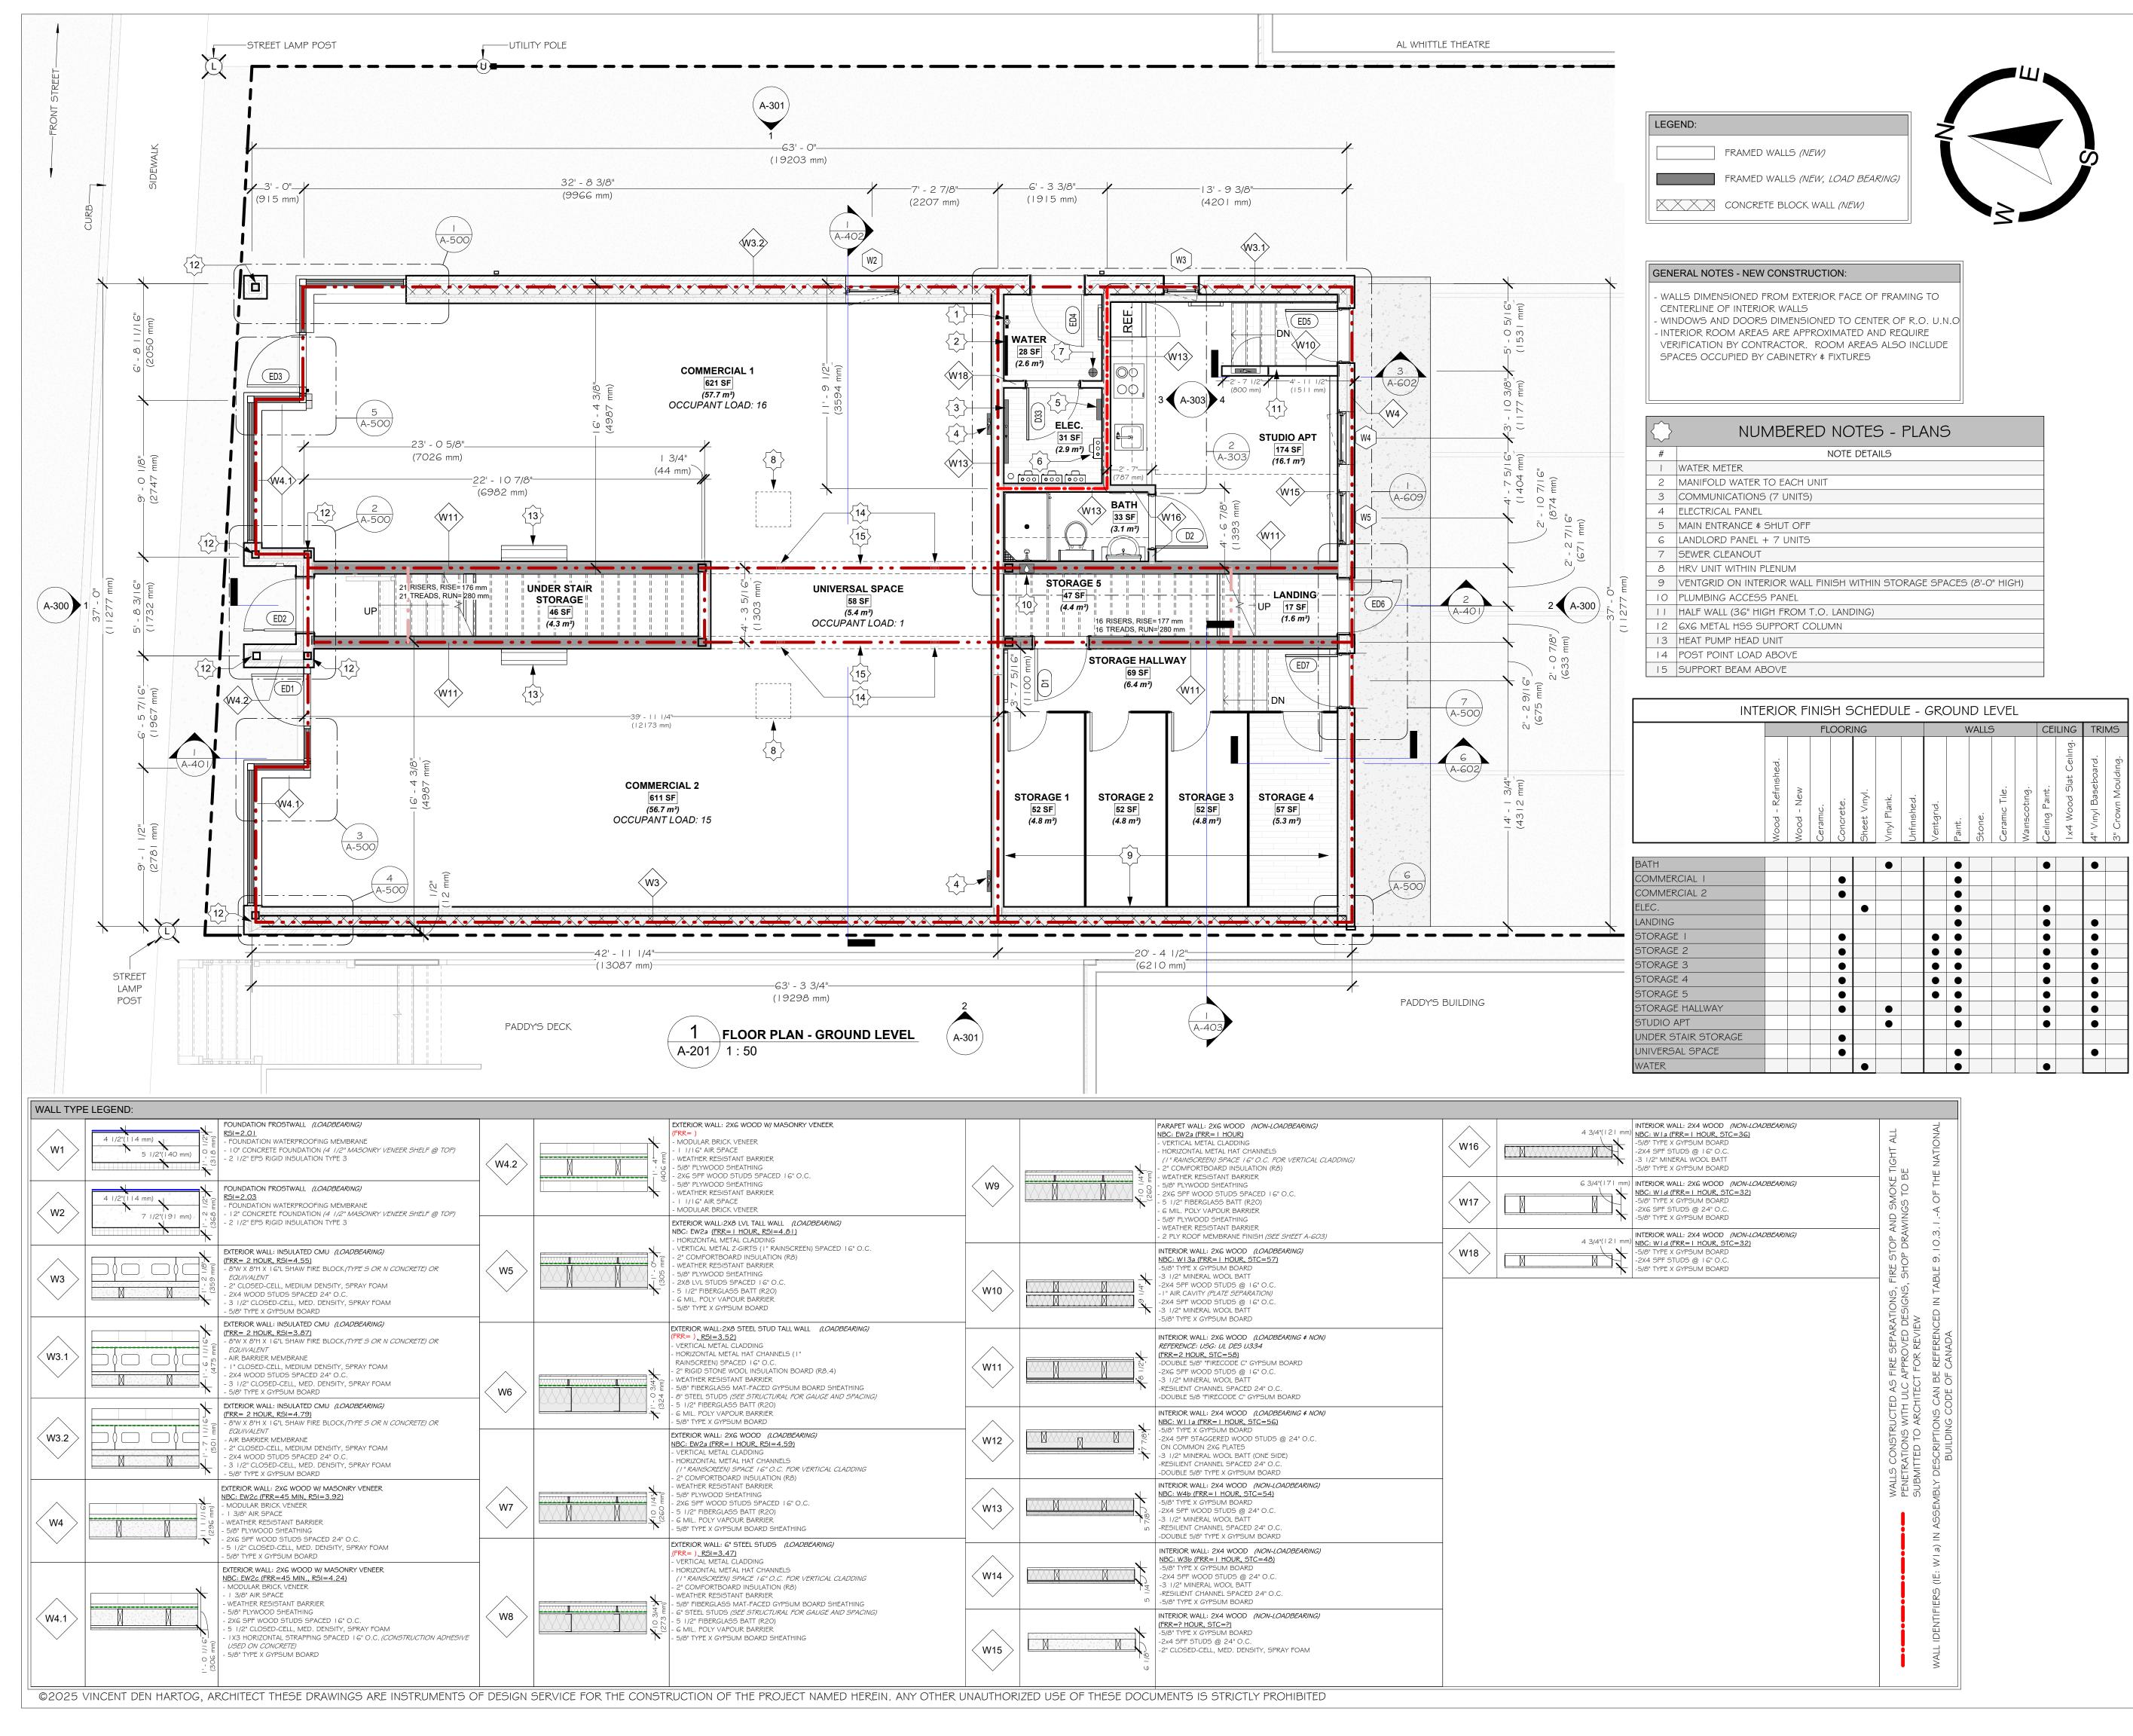

KEY PLAN:


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OTHER CONSULTANT'S STAMP ARCHITECT'S STAMP

FRONT STREET **APARTMENTS**

456 MAIN STREET WOLFVILLE, NS PID: 55279087

Construction Documents

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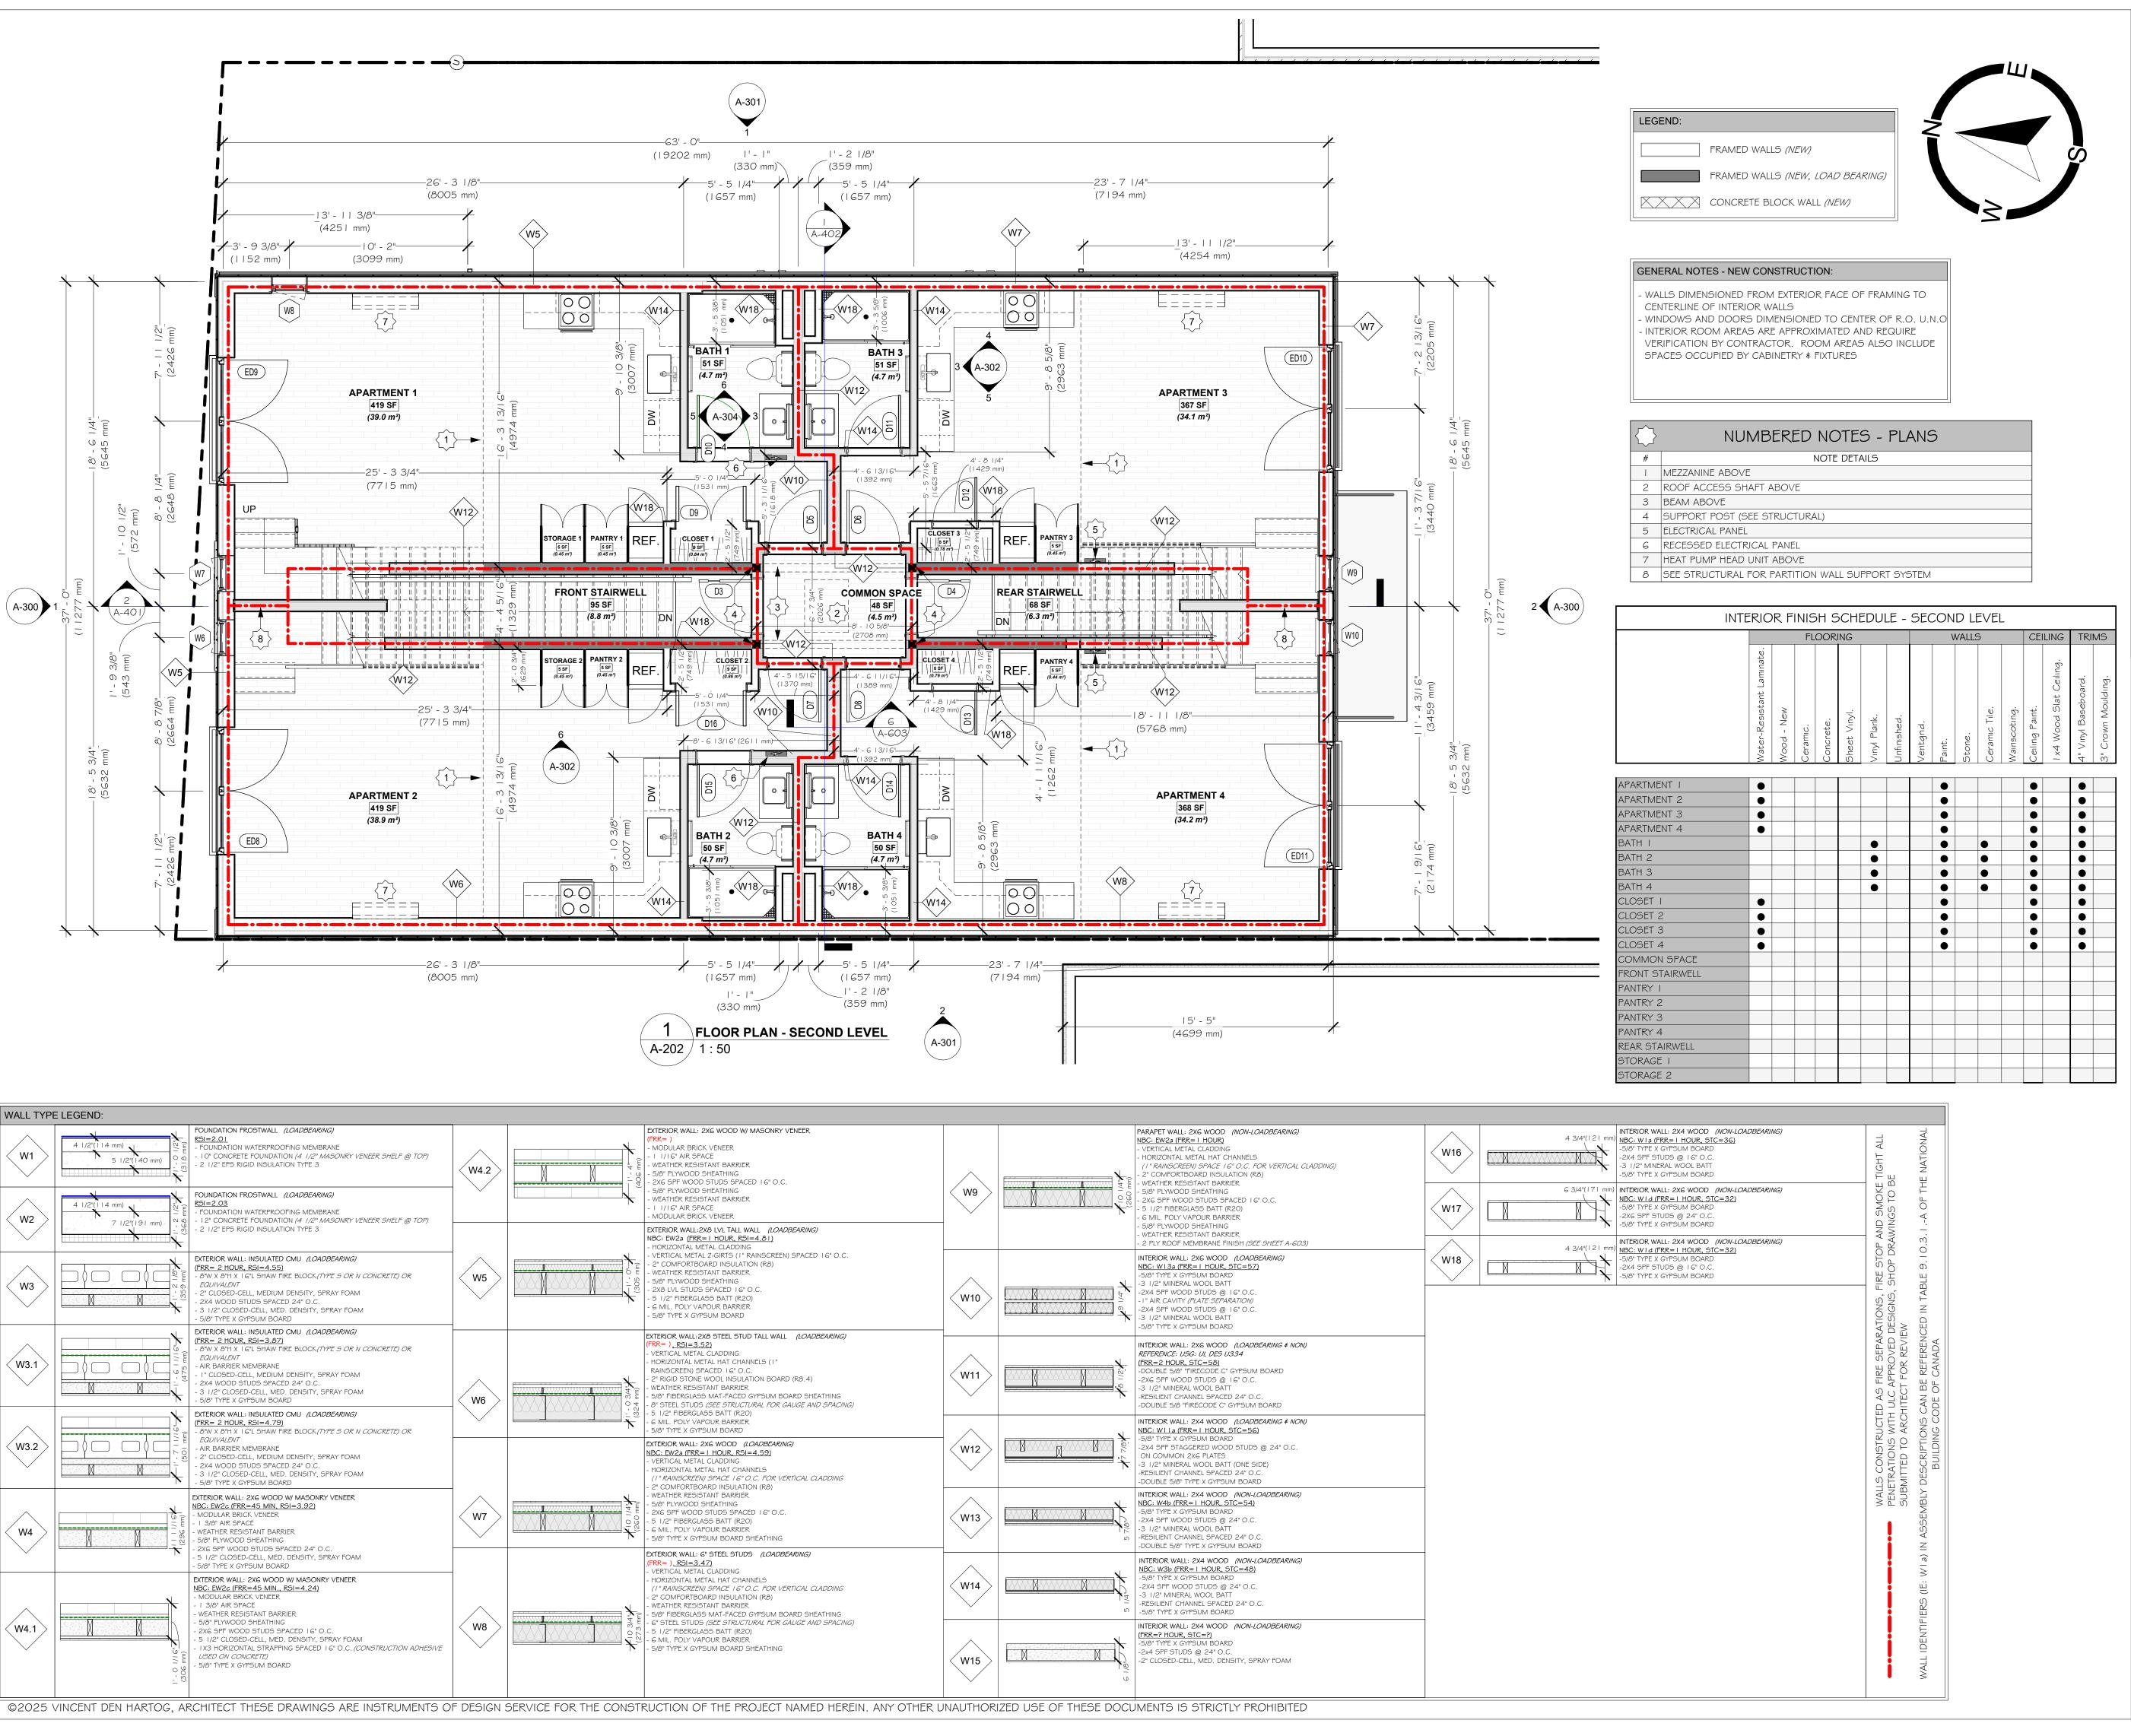
VINCENT DEN HARTOG Architect

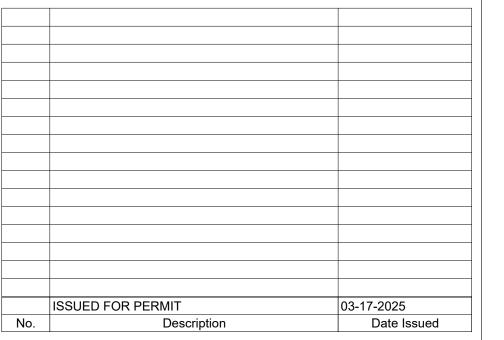176 Main Street, Wolfville, Nova Scotia, B4P 1C1 Email:info@denhartogarchitect.com

Tel: 902 542-4194 Website:www.denhartogarchitect.com

FLOOR PLAN - GROUND LEVEL

Scale: As indicated Drawn By: DSW Checked By: VDH



KEY PLAN:


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- 6. ALL WORK SHALL BE PERFORMED IN ACCORDANCE WITH THE LABOUR AND HEALTH AND SAFETY LAWS AND REGULATIONS OF THE AUTHORITY HAVING JURISDICTION.



Vincent den Hartog

Vincen

FRONT STREET APARTMENTS

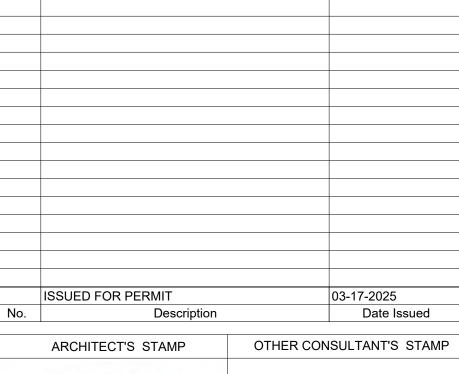456 MAIN STREET WOLFVILLE, NS PID: 55279087

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Architecture for rural communities

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Architect


FLOOR PLAN - SECOND LEVEL


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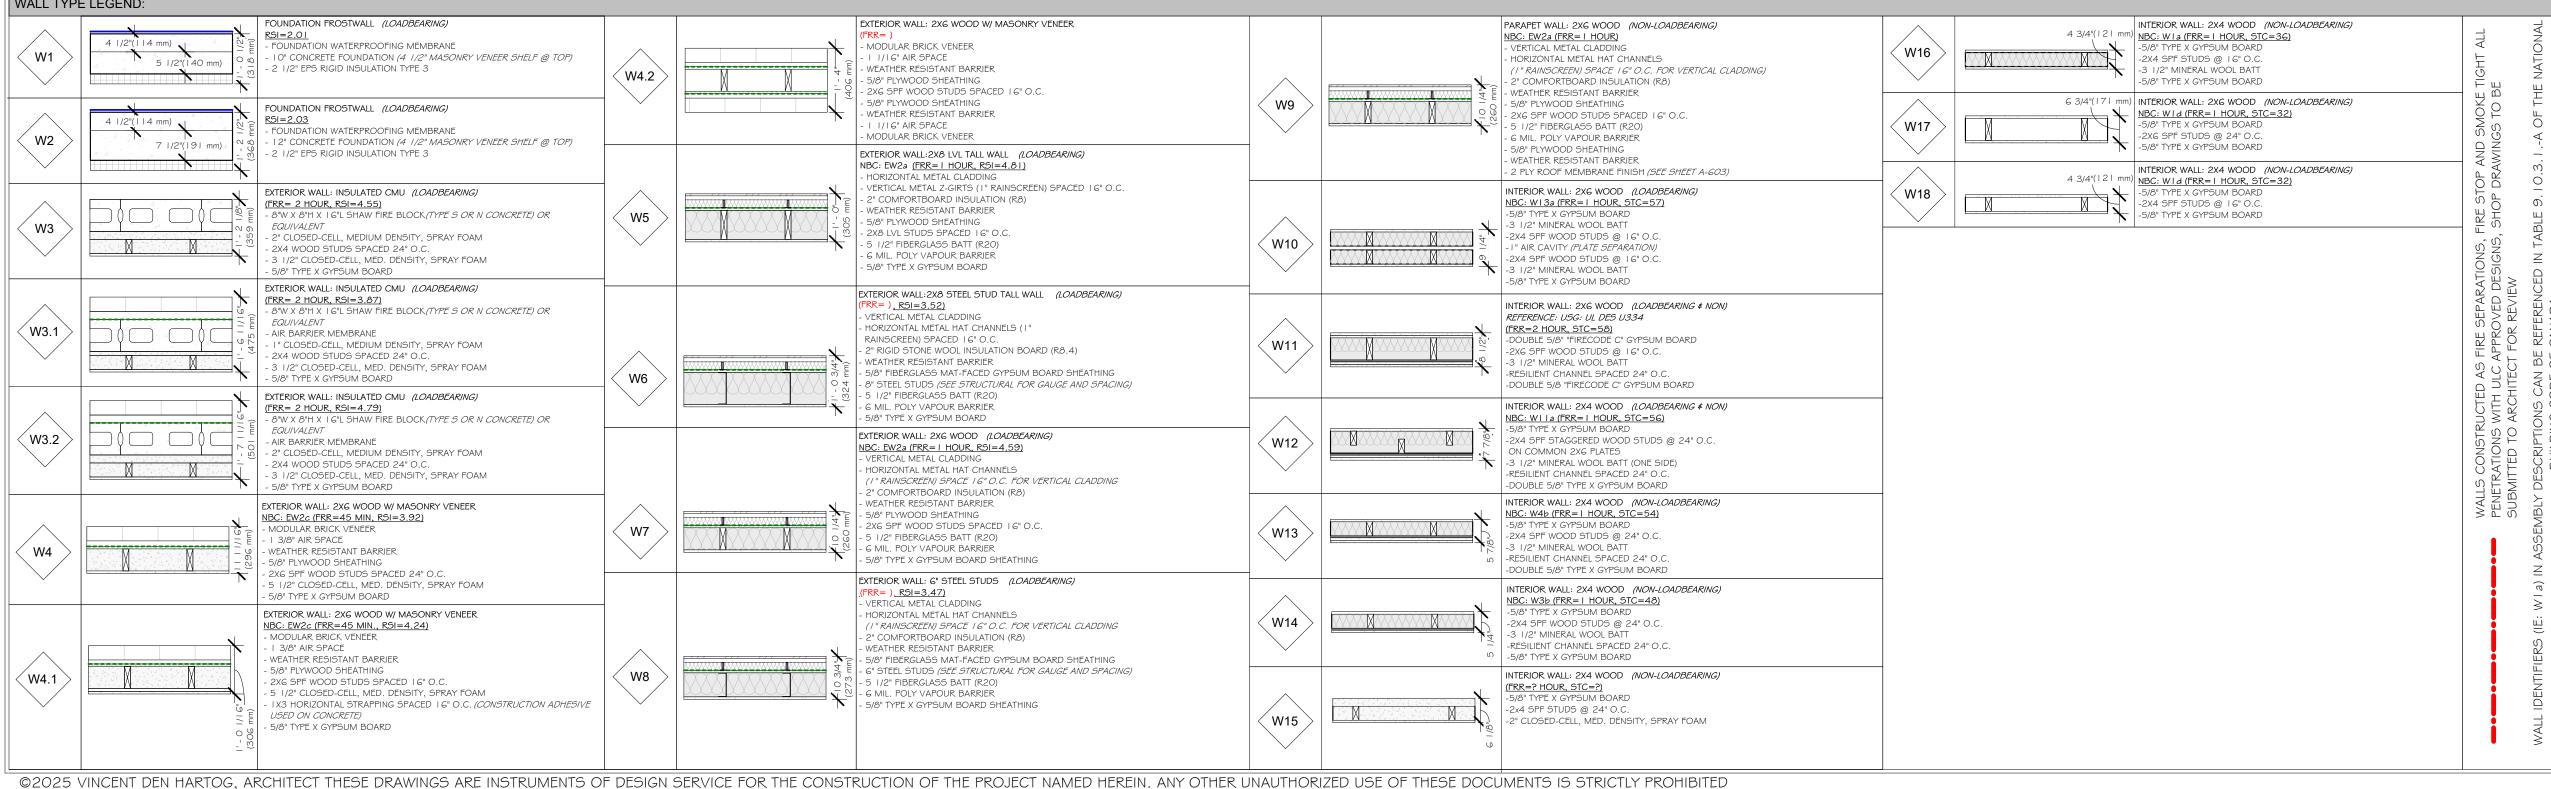
GENERAL NOTES - NEW CONSTRUCTION:

- WALLS DIMENSIONED FROM EXTERIOR FACE OF FRAMING TO
- CENTERLINE OF INTERIOR WALLS WINDOWS AND DOORS DIMENSIONED TO CENTER OF R.O. U.N.O
- INTERIOR ROOM AREAS ARE APPROXIMATED AND REQUIRE VERIFICATION BY CONTRACTOR. ROOM AREAS ALSO INCLUDE SPACES OCCUPIED BY CABINETRY & FIXTURES

| \Diamond | NUMBERED NOTES - PLANS |
|------------|--|
| # | NOTE DETAILS |
| 1 | BUILT-IN SHELVES |
| 2 | SEE STRUCTURAL FOR PARTITION WALL SUPPORT SYSTEM |
| 3 | 36" X 30" ROOF ACCESS HATCH |
| 4 | STORAGE CABINET |
| 5 | HEAT PUMP HEAD UNIT ABOVE |
| 6 | OPEN TO BELOW |

| INTER | RIOF | R FIN | IISt | 1 50 | CHE | DULE | - N | 1EZZ | ZAN | INE | LEVI | EL | | | | |
|-------------|--------------------|------------|----------|-----------|--------------|--------------|-------------|-----------|--------|--------|---------------|--------------|----------------|------------------------|---------------------|--------------------|
| | | | FL | .OOR | ING | | | | ٧ | VALLS | 5 | | CEI | LING | TRIMS | |
| | Wood - Refinished. | Wood - New | Ceramic. | Concrete. | Sheet Vinyl. | Vinyl Plank. | Unfinished. | Ventgrid. | Paint. | Stone. | Ceramic Tile. | Wainscoting. | Ceiling Paint. | 1x4 Wood Slat Celling. | 4" Vinyl Baseboard. | 3" Crown Moulding. |
| APARTMENT I | • | | | | | | | | • | | | | • | | • | |
| APARTMENT 2 | • | | | | | | | | • | | | | • | | • | |
| APARTMENT 3 | | | | | | | | | • | | | | • | | • | |

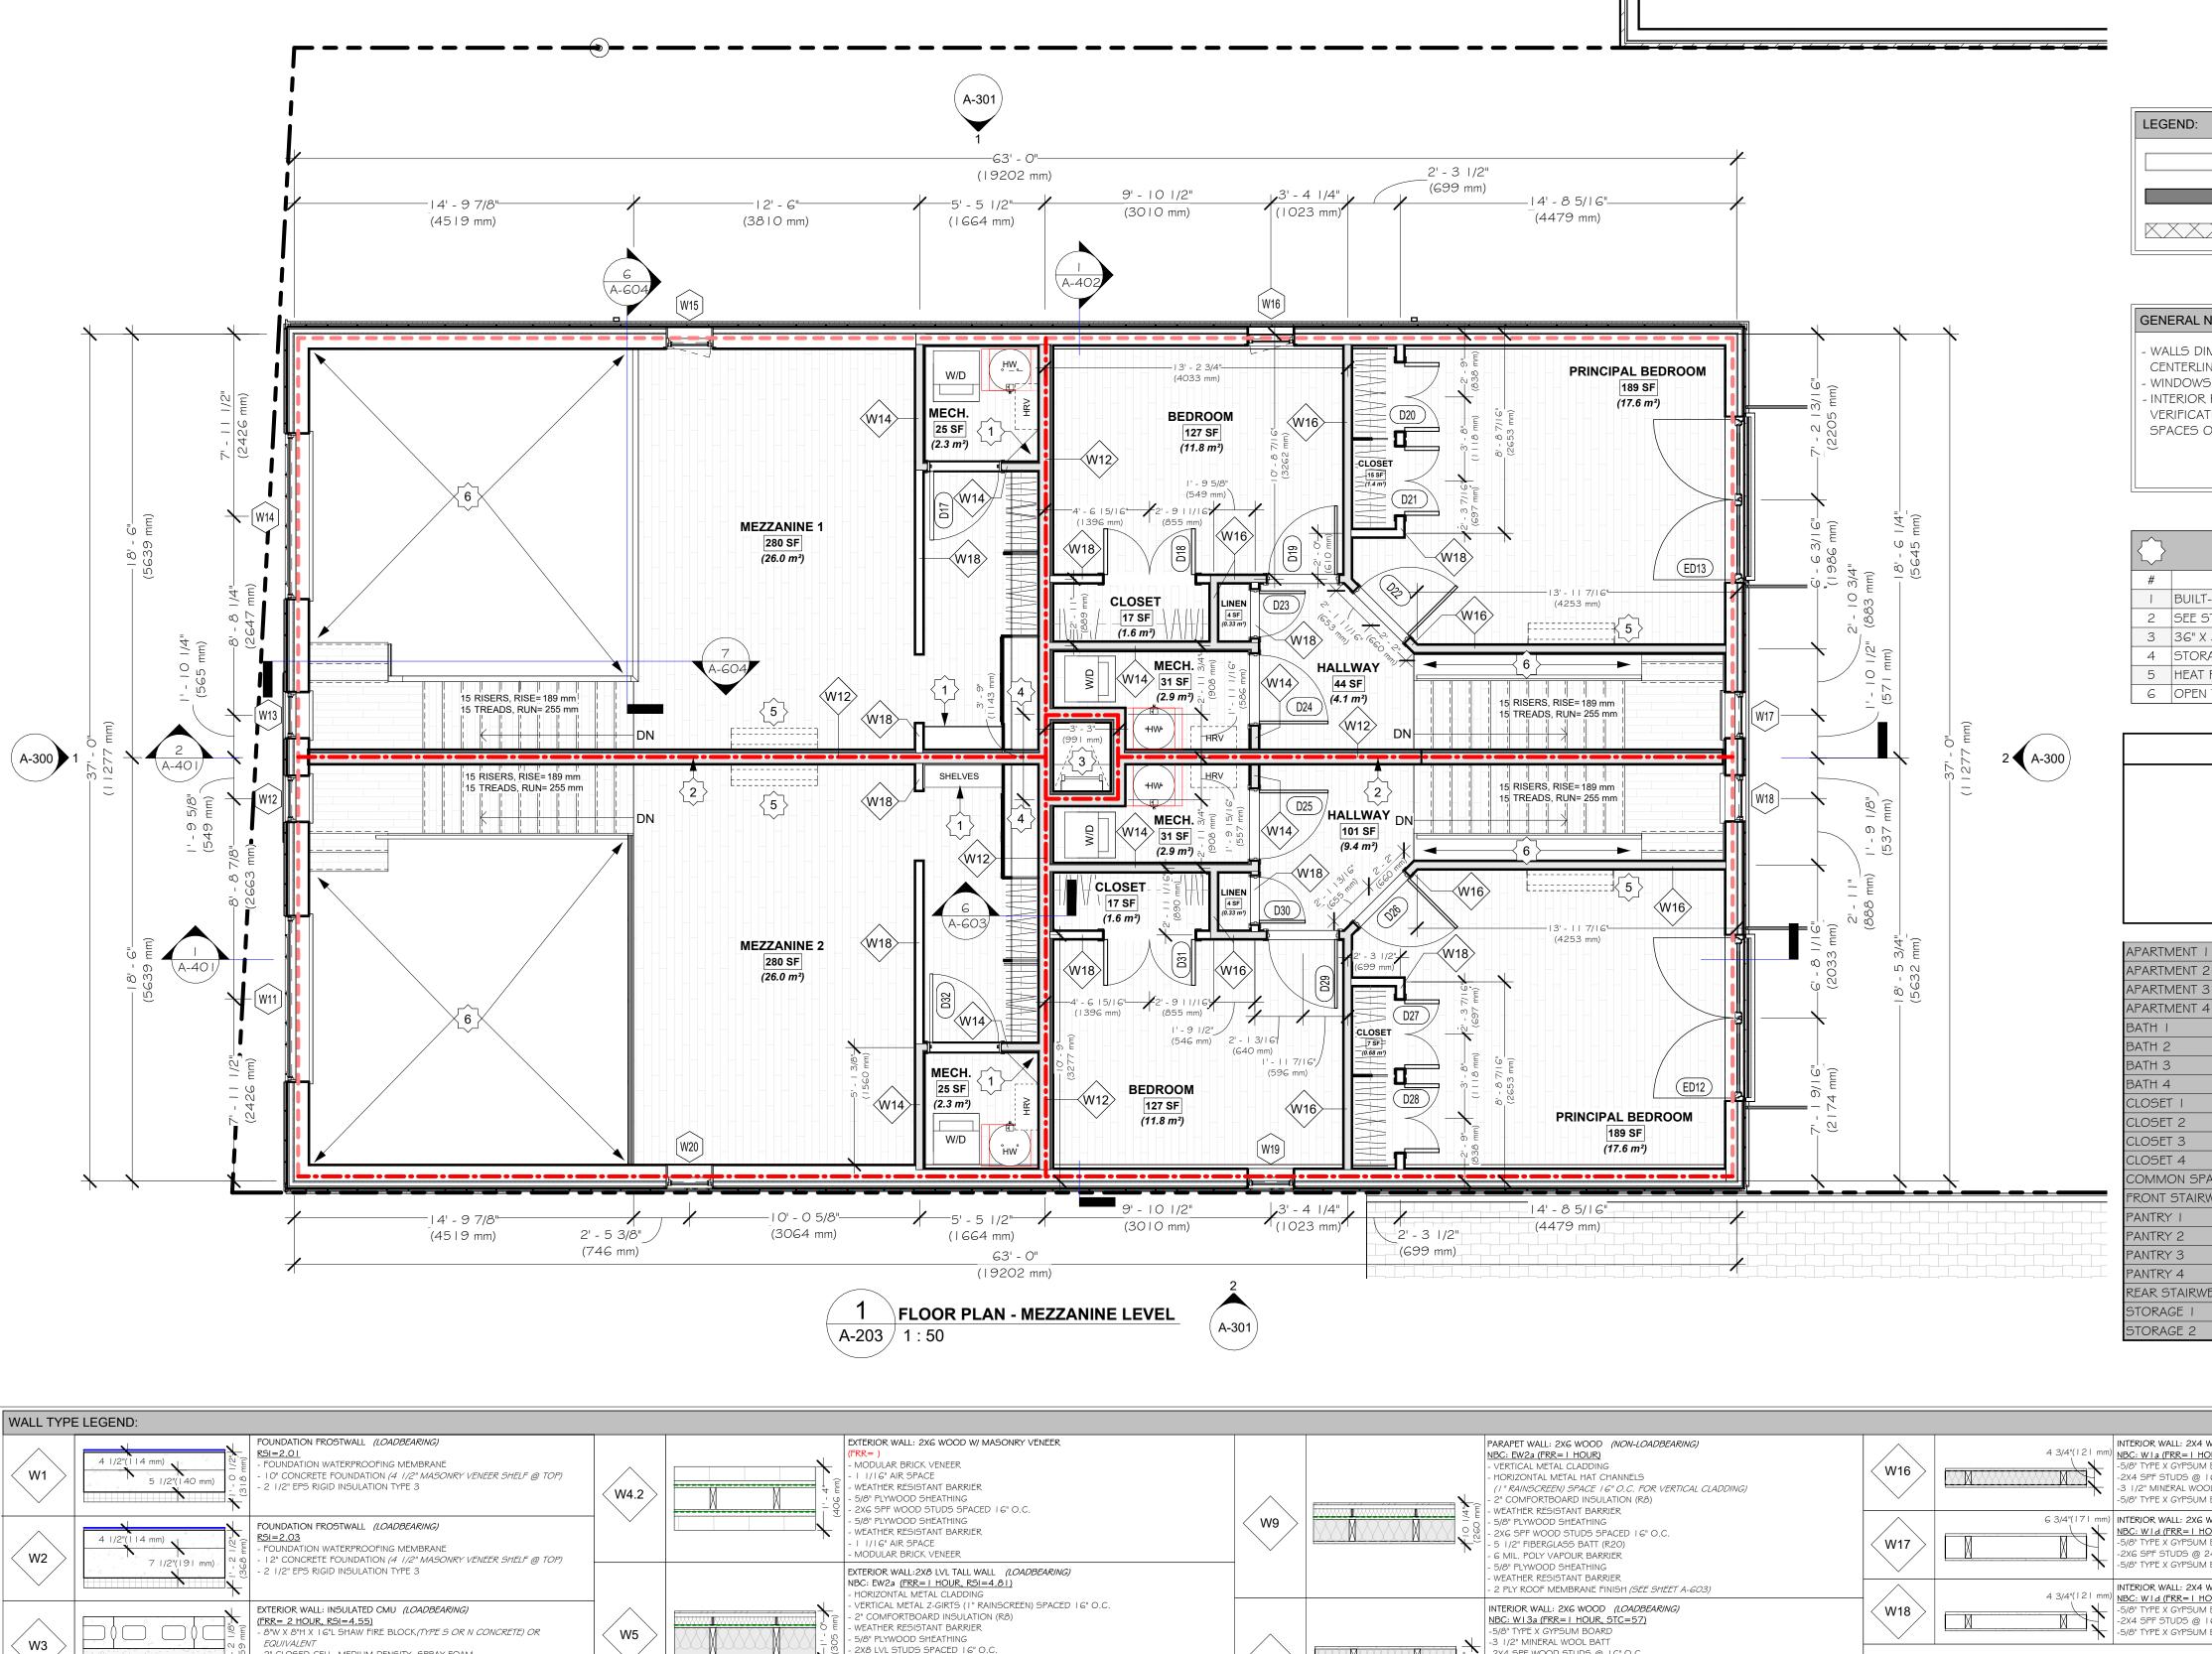
| APARTMENT I | | | | | | | • | • | |
|-----------------|---|--|---|--|---|---|---|---|--|
| APARTMENT 2 | • | | | | • | | • | • | |
| APARTMENT 3 | • | | | | • | | • | • | |
| APARTMENT 4 | • | | | | • | | • | • | |
| BATH I | | | • | | • | • | • | • | |
| BATH 2 | | | • | | • | • | • | • | |
| BATH 3 | | | • | | • | • | • | • | |
| BATH 4 | | | • | | • | • | • | • | |
| CLOSET I | • | | | | • | | • | • | |
| CLOSET 2 | • | | | | • | | • | • | |
| CLOSET 3 | • | | | | • | | • | • | |
| CLOSET 4 | • | | | | • | | • | • | |
| COMMON SPACE | | | | | | | | | |
| FRONT STAIRWELL | | | | | | | | | |
| PANTRY I | | | | | | | | | |
| PANTRY 2 | | | | | | | | | |
| PANTRY 3 | | | | | | | | | |
| PANTRY 4 | | | | | | | | | |
| REAR STAIRWELL | | | | | | | | | |
| STORAGE I | | | | | | | | | |
| STORAGE 2 | | | | | | | | | |

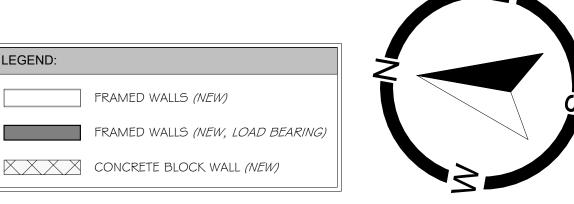

KEY PLAN:

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| ARCHITECT'S STAMP | OTHER CONSULTANT'S STAMP |
|--|--------------------------|
| Vincent den Hartog Vincent den Hartog Vincent den Hartog VINCENT H 2025/ 44 VINCEN | |

FRONT STREET **APARTMENTS**

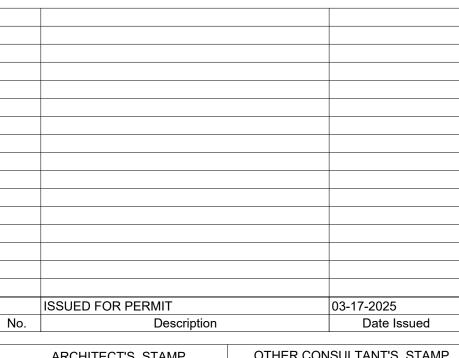456 MAIN STREET WOLFVILLE, NS PID: 55279087

Construction Documents

Project #: 2023-389-01 Project PID: 55499602 Date: 2025-03-17

MIKE HEBB & JASON KEATING

456 MAIN ST., WOLFVILE, NS B4P 1E2



Architecture for rural communities

VINCENT DEN HARTOG

176 Main Street, Wolfville, Nova Scotia, B4P 1C1 Email:info@denhartogarchitect.com

Tel: 902 542-4194 Website:www.denhartogarchitect.com

Architect

FLOOR PLAN - MEZZANINE LEVEL

Scale: As indicated Drawn By: Author Checked By: VDH



| EXTERIOR FINISHES | | | | | | | | | |
|-------------------|-------------------------|-------|-------|---|--|--|--|--|--|
| | MATERIAL | HATCH | IMAGE | DESCRIPTION | | | | | |
| 1 | VERTICAL SIDING | | | MAC METALS (METAL) PROFILE: MS MODULAR COLOUR: DARK BROWN CORNER TRIM: ONYX BLACK | | | | | |
| 2 | HORIZONTAL SIDING | | | RAILUX (METAL) PROFILE: TIAGO COLOUR: EBONY | | | | | |
| 3 | STONE VENEER | | | SHAW BRICK (MASONRY VENEER) PROFILE: MODULAR/COMMON COLOUR: MARITIME ACADIAN | | | | | |
| 4 | STONE VENEER | | | SHAW BRICK (MASONRY VENEER) PROFILE: MODULAR/SOLDIER COLOUR: TAPESTRY GREY | | | | | |
| 5 | CONCRETE BLOCK | | | BRAMPTON BRICK (75% SOLID) PROFILE: I 50mm FIRE RESISTANCE RATING: 2HR COLOUR: STANDARD | | | | | |
| 6 | 2 PLY BUILT- UP ROOF | | | SOPREMA (MODIFIED BITUMEN) CONVENTIONAL SELF-ADHERED (WOOD DECK) COLOUR: STANDARD | | | | | |
| 7 | SIGNAGE CANVAS | | | STOREFRONT SIGNAGE PROFILE: T.B.D. | | | | | |

SIDING NOTES: SIDING TO BE A COMBINATION OF MS 1, MS 1.1, \$ MS 1.2

MODULAR PROFILES FROM MAC METALS. SEPARATE VERTICAL SIDING SECTIONS

(ABOVE AND BELOW BAND TRIM AROUND PERIMETER OF BUILDING)TO HAVE RIBS

CONSISTENTLY MISALIGNED VERTICALLY BY ALTERNATING MODULAR SIDING PROFILES

ROOFING NOTES: REFER TO SOPREMA "CONVENTIONAL SELF-ADHERED (WOOD DECK)" ASSEMBLY FOR SYSTEM COMPONENTS

ROOF TYPE LEGEND:

FLAT ROOF - MONOPITCH TRUSSES - FLAT CEILING (RSI=9.38):

-2 PLY MODIFIED BITUMEN ROOFING

-2 LAYERS OF 3" XPS RIGID INSULATION (SEAL SEAMS)

-SYNTHETIC UNDERLAYMENT -3/4" T&G PLYWOOD SHEATHING

-3/4" 1#G PLYWOOD SHEATHING -PRE-ENGINEERED MONOPITCH TRUSSES SPACED 24" O.C.

-5" CLOSED CELL, MEDIUM DENSITY, SPRAY FOAM (APPLIED TO UNDERSIDE OF ROOF DECK AND BUILDING PERIMETER)
-1X3 STRAPPING SPACED 16" O.C.

-5/8" TYPE X GYPSUM BOARD

FLAT ROOF - SUSPENDED CABLE :

-METAL ROOFING

-METAL ARRAY FRAMING (JOISTS & RIMS)
-SEE STRUCTURAL FOR CONSTRUCTION DETAILS


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| | ISSUED FOR PERMIT | 03-17-2025 |
|-----|-------------------|-------------|
| No. | Description | Date Issued |
| | | |



FRONT STREET APARTMENTS

456 MAIN STREET WOLFVILLE, NS PID: 55279087

Phase: Construction Documents

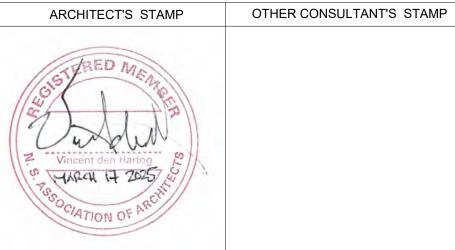Project #: 2023-389-0 |
Project PID: 55499602
Date: 2025-03- | 7

MIKE HEBB & JASON KEATING

456 MAIN ST., WOLFVILE, NS B4P 1E2



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Architect

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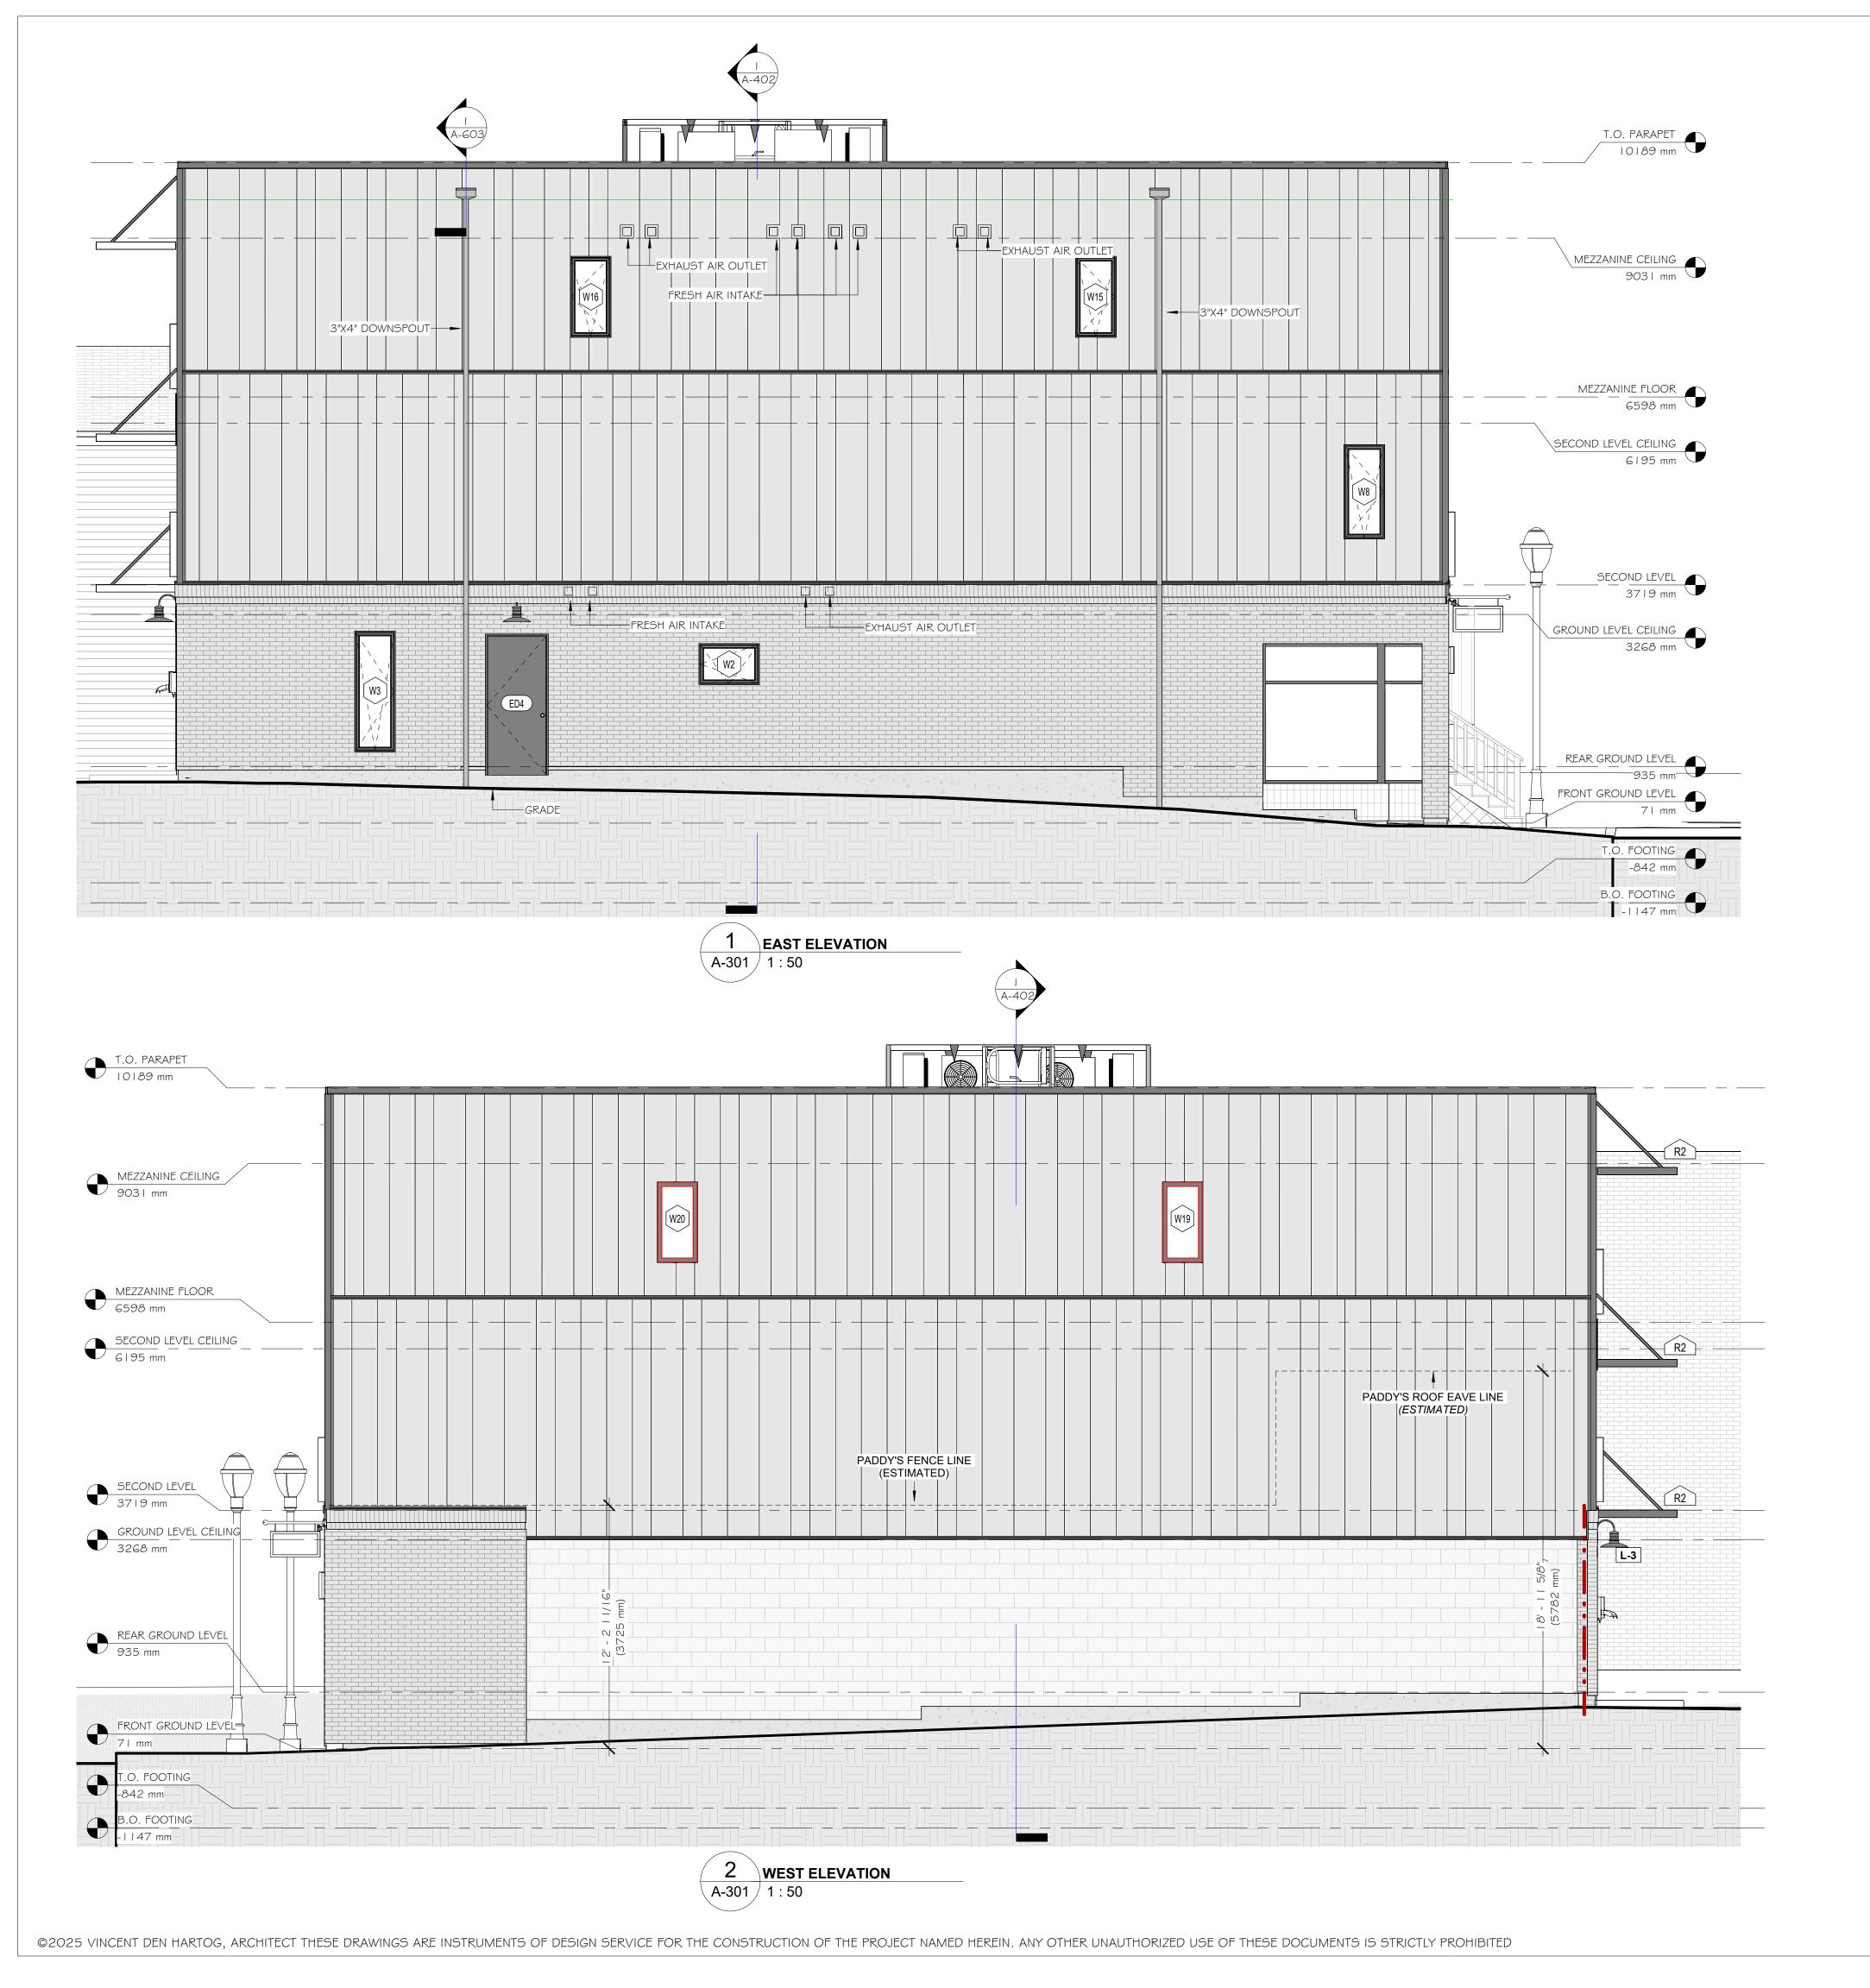
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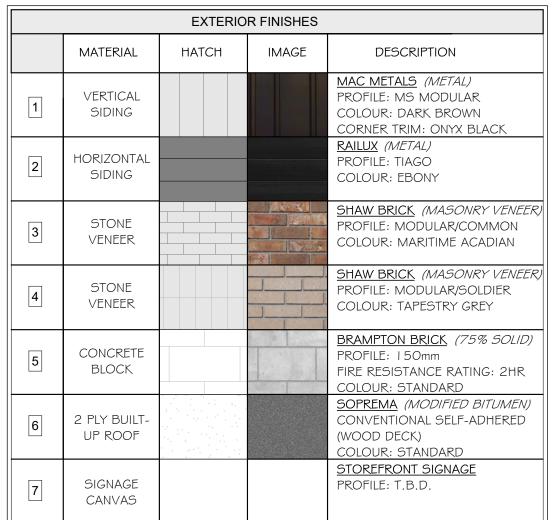
BUILDING ELEVATIONS - NORTH / SOUTH

Scale: As indicated

Drawn By: Author

A-300





SIDING NOTES: SIDING TO BE A COMBINATION OF MS 1, MS 1.1, \$ MS 1.2

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ARCHITECT'S STAMP

OTHER CONSULTANT'S STAMP

Vincent den Hartog

FRONT STREET APARTMENTS

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Architect

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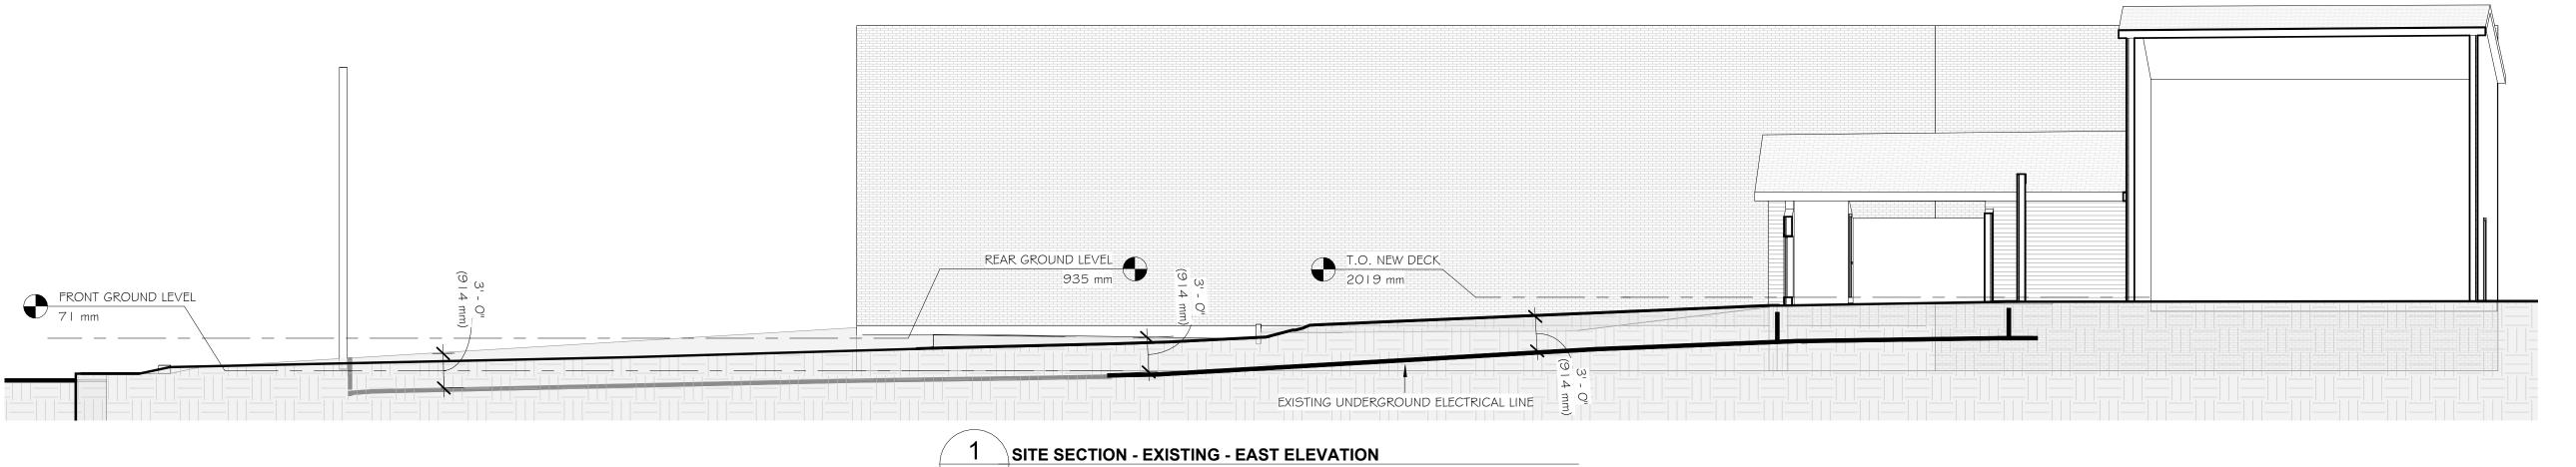
BUILDING ELEVATIONS -EAST / WEST

Scale: As indicated


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Checked By: VDH

A-301





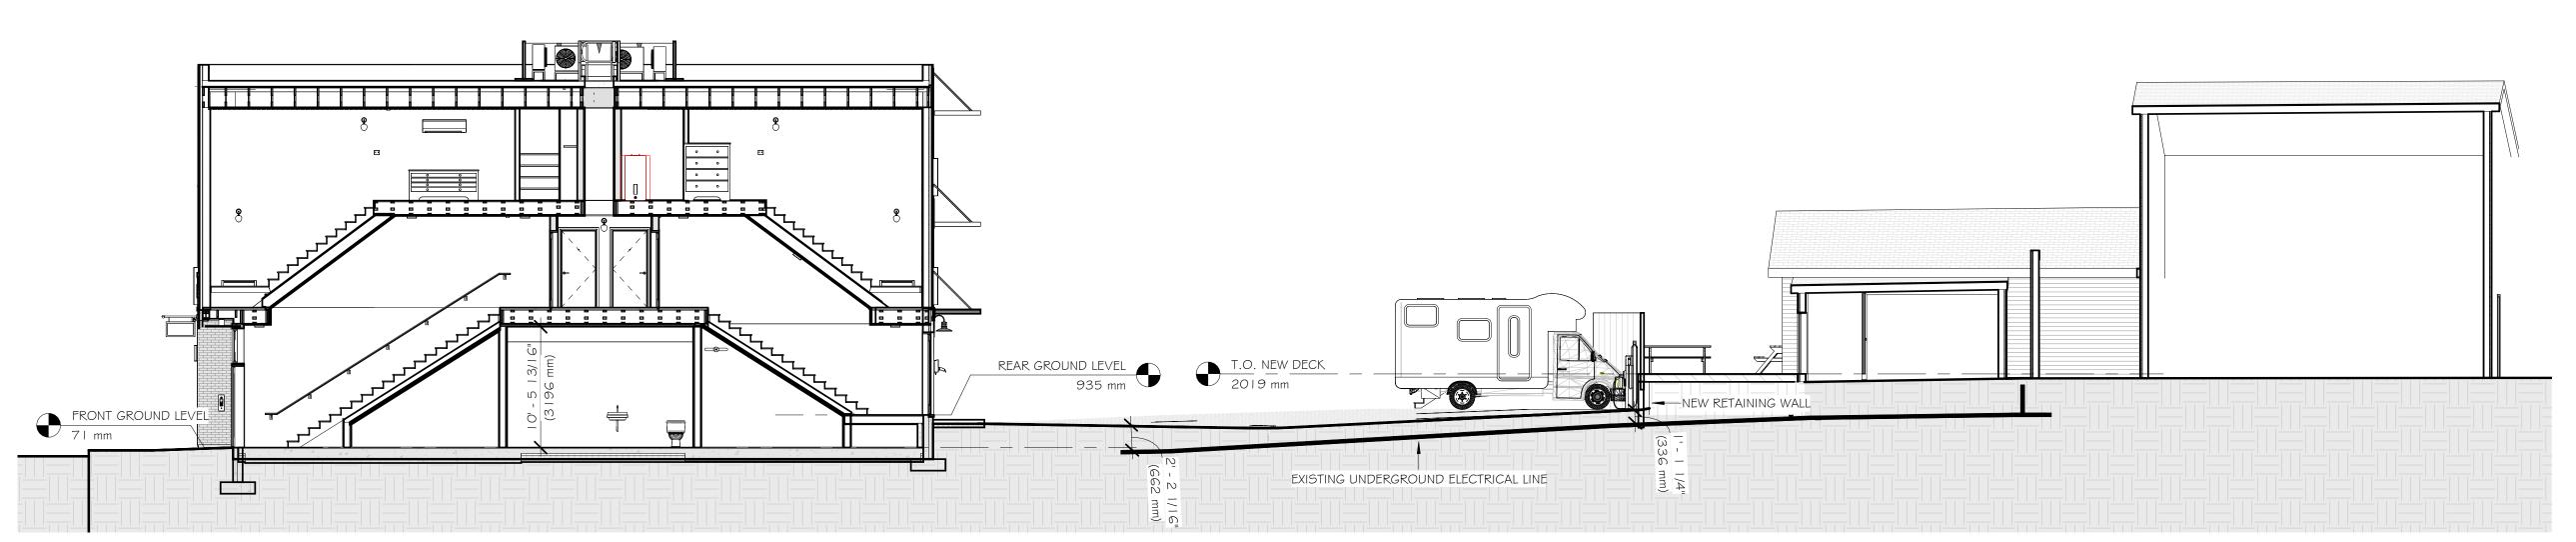

2 SITE SECTION - NEW- EAST ELEVATION


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|--|--------------------------|
| Vincent den Hartog Vincent den Hartog | |

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Project #: 2023-389-01 Project PID: 55499602 Date: 2025-03-17

MIKE HEBB & JASON KEATING

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Architecture for rural communities

Vincent den Hartog Architect

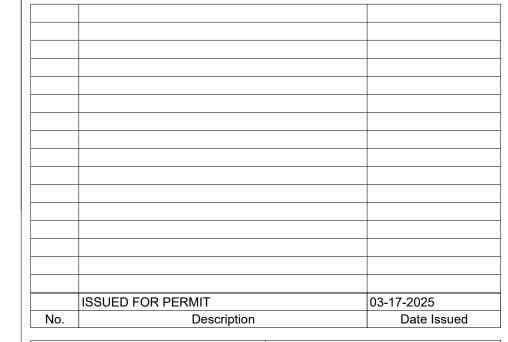
176 Main Street, Wolfville, Nova Scotia, B4P 1C1 Email:info@denhartogarchitect.com Website:www.denhartogarchitect.com

BUILDING ELEVATIONS -SITE SECTION - EAST VIEW

Drawn By: Author

Checked By: ∨DH

Tel: 902 542-4194

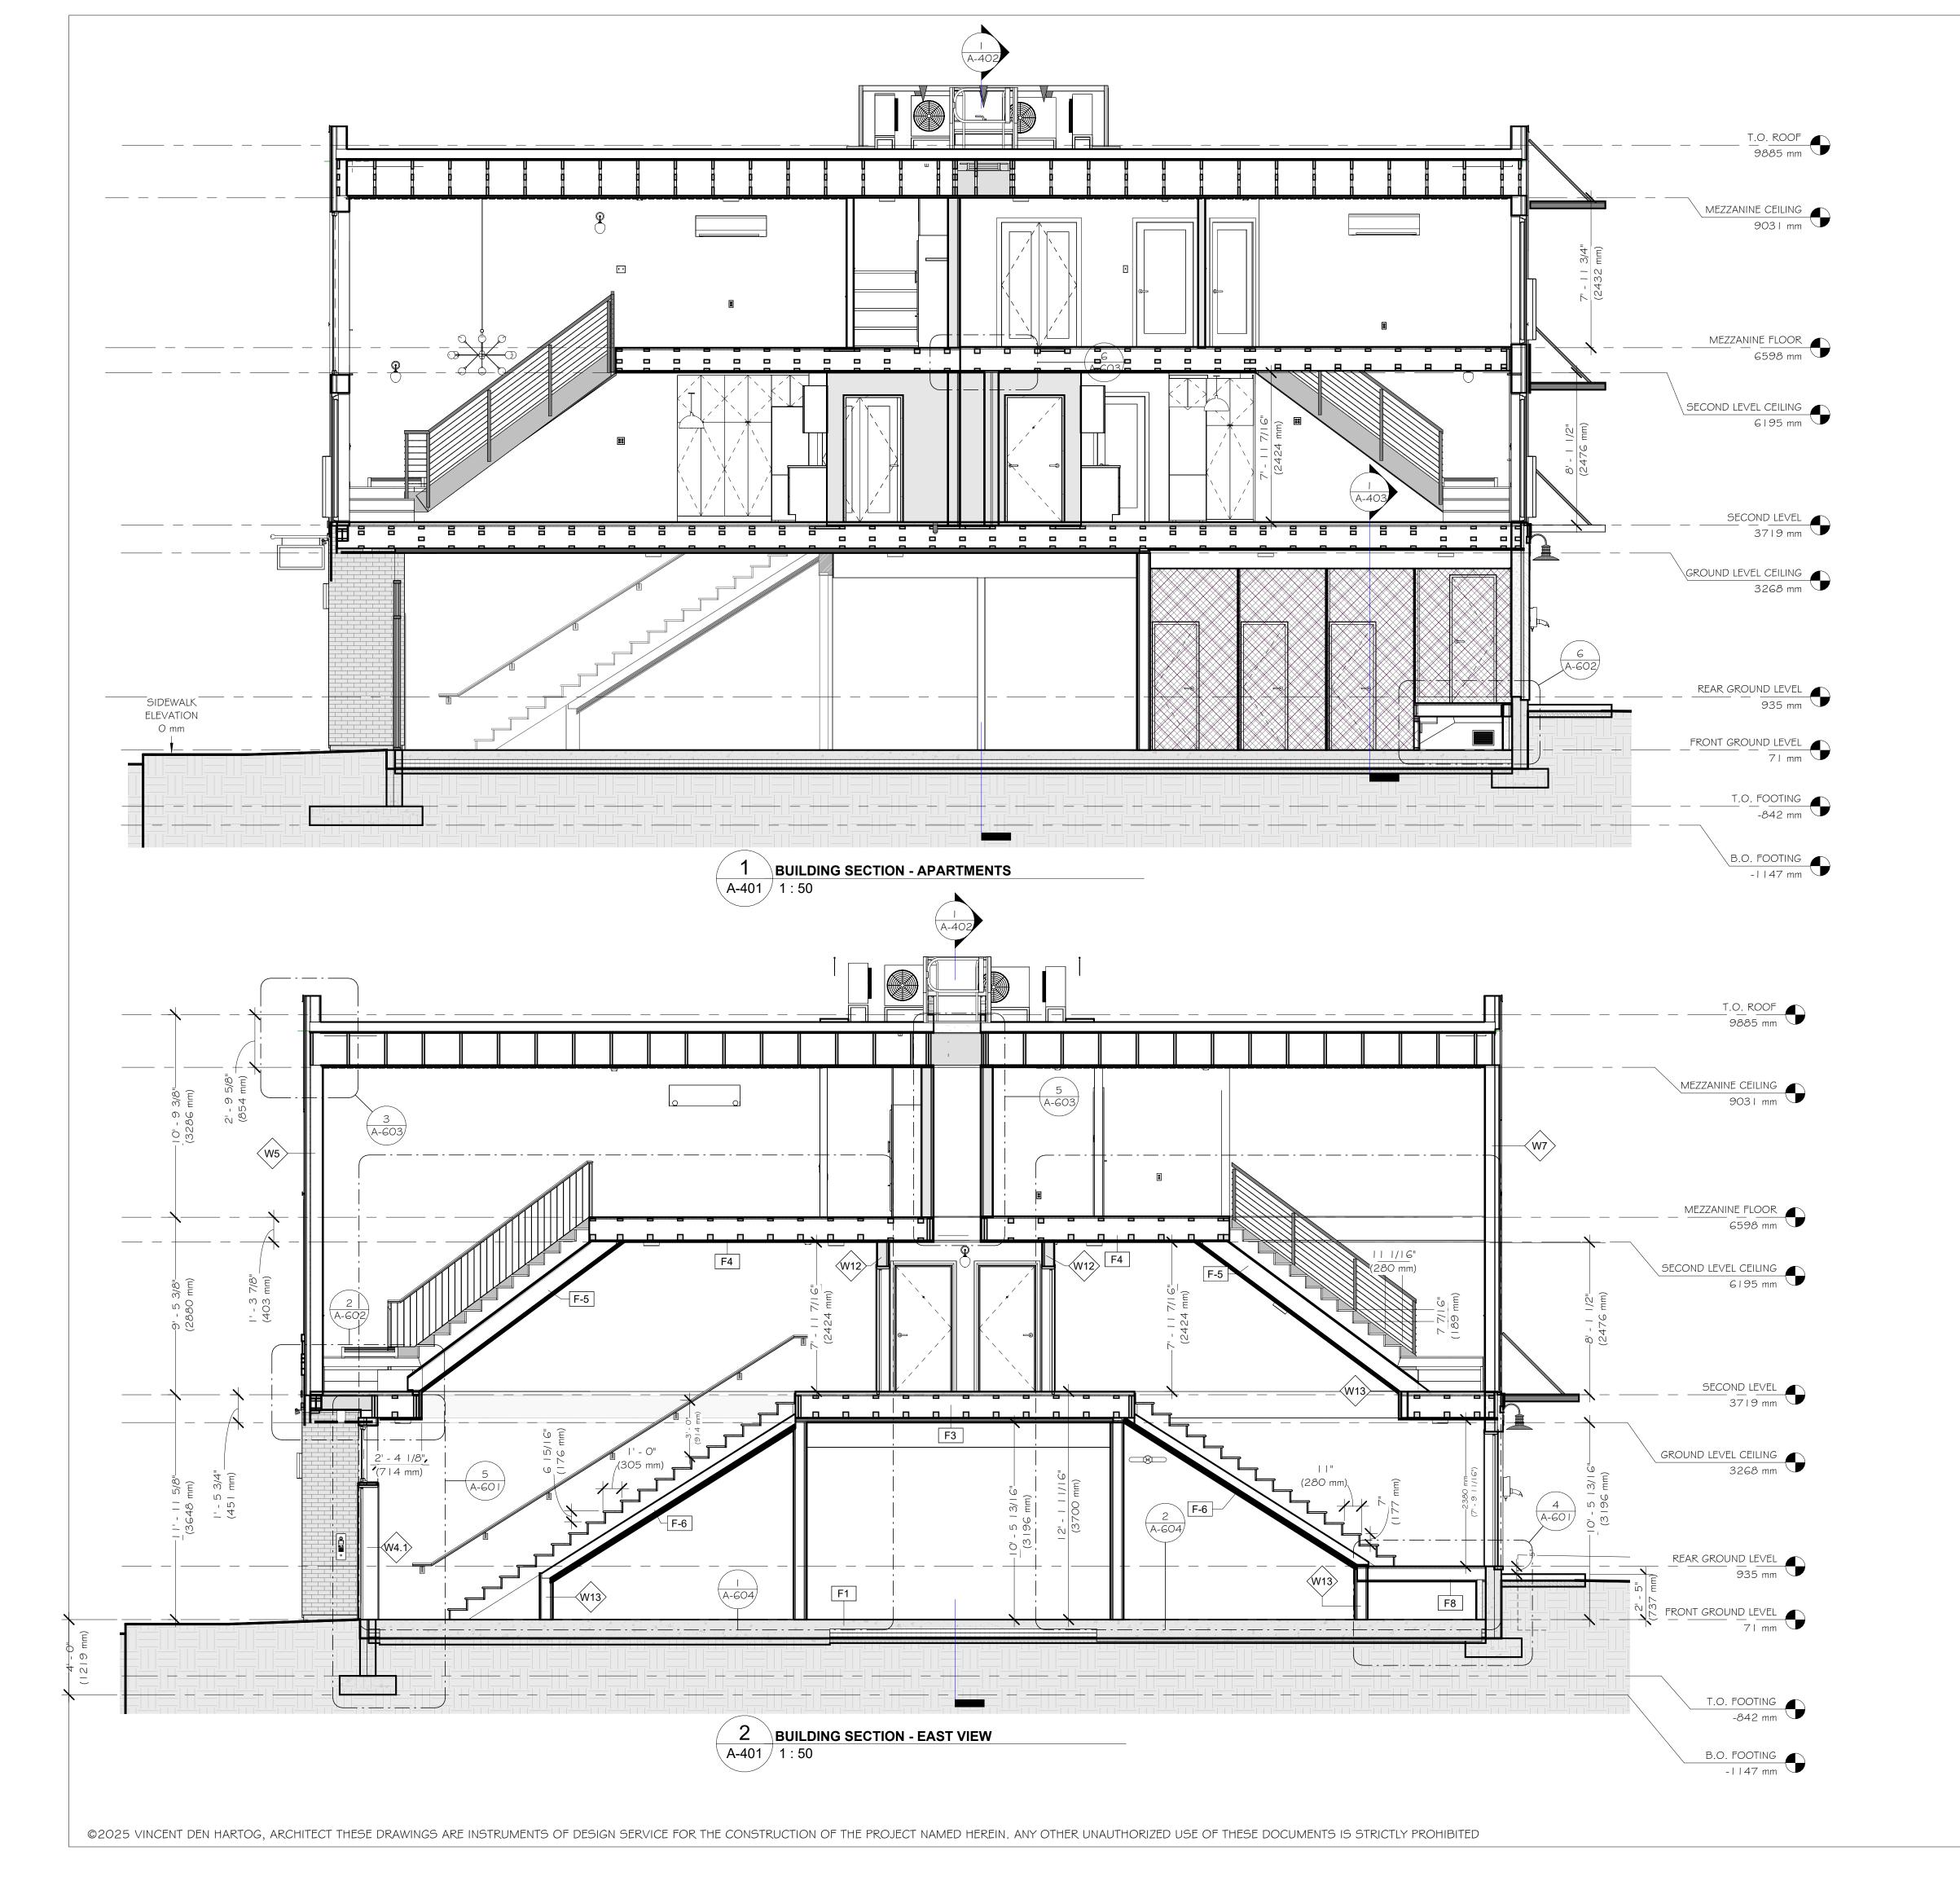



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FRONT STREET APARTMENTS

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Construction Project #: Documents
Project PID: 55499602 2025-03-17

> MIKE HEBB & JASON KEATING

> > 456 MAIN ST., WOLFVILE, NS B4P 1E2

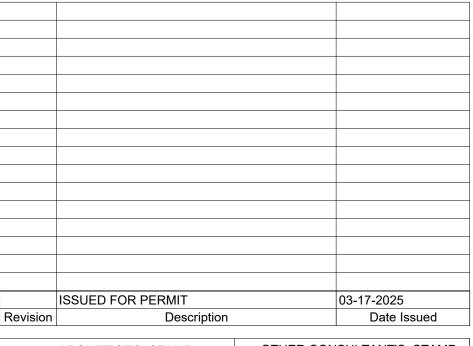

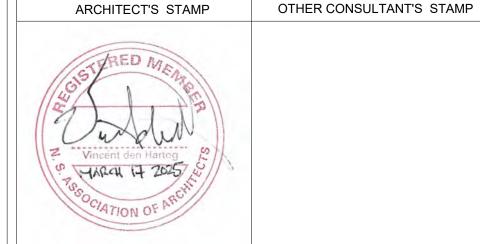Architecture for rural communities


Vincent den Hartog Architect

176 Main Street, Wolfville, Nova Scotia, B4P 1C1 Email:info@denhartogarchitect.com Website:www.denhartogarchitect.com

BUILDING SECTION - EAST

VIEWS **Scale**: 1 : 50

Drawn By: DS Checked By: VDH

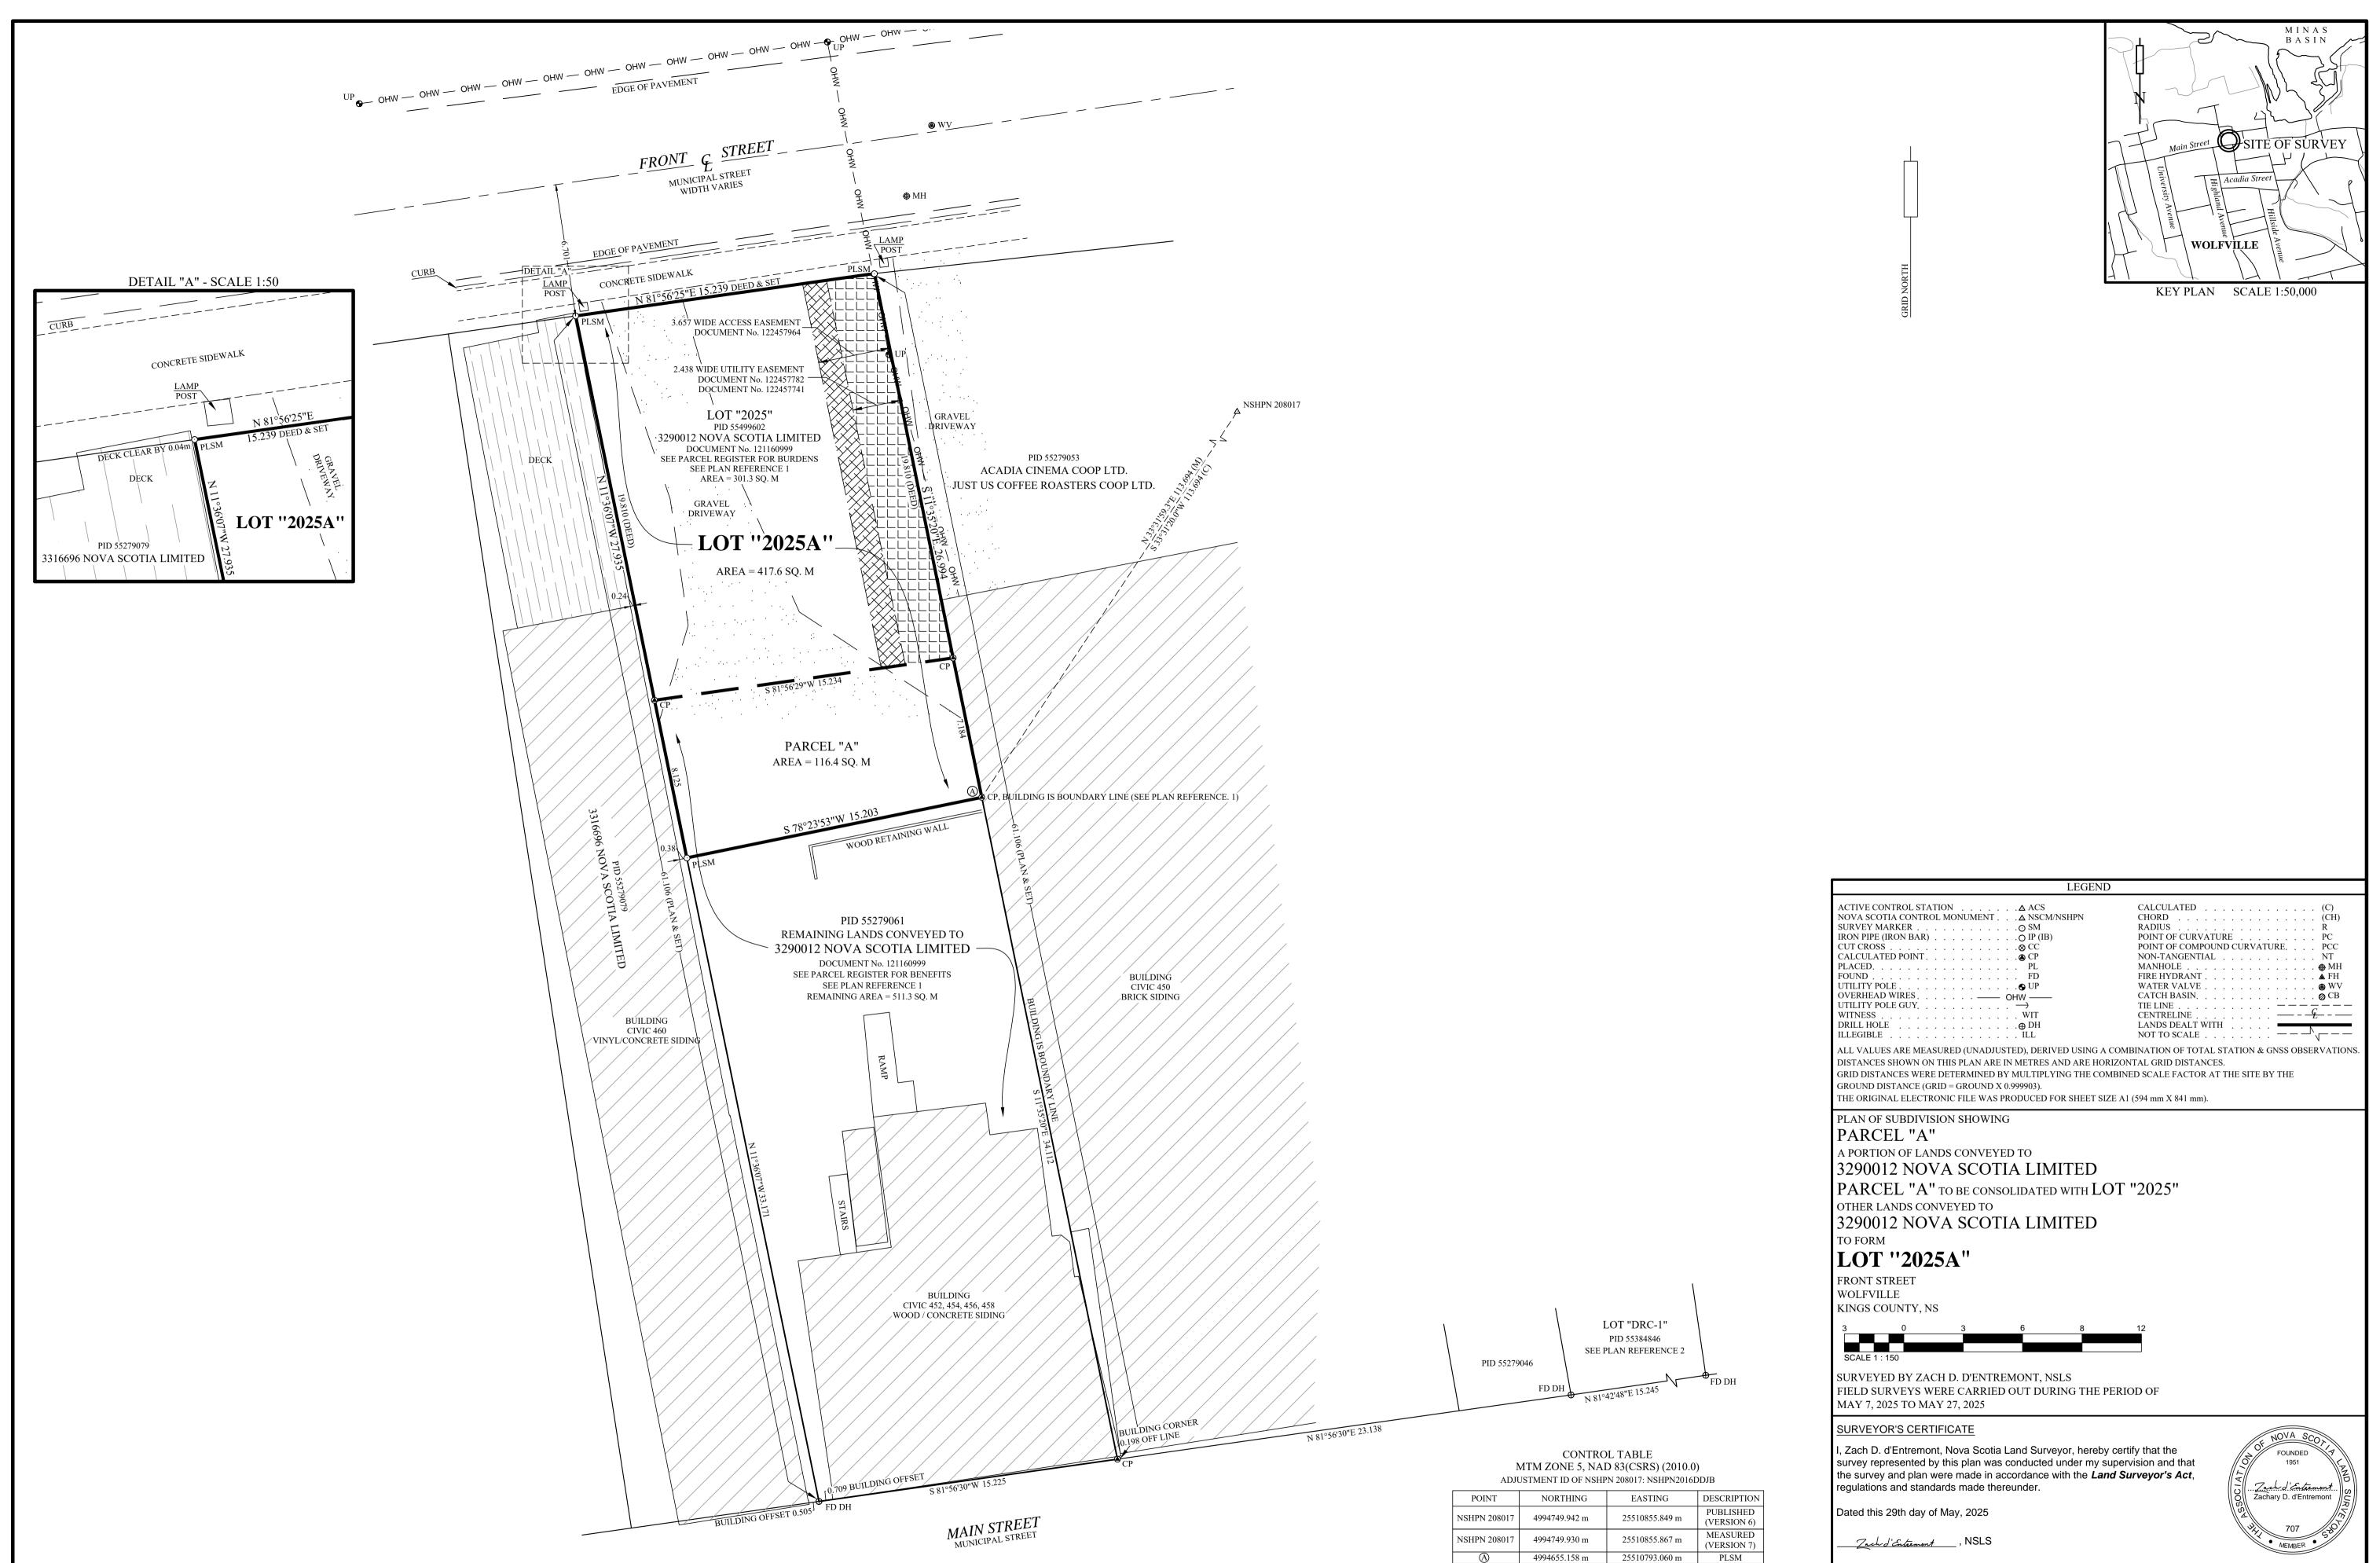

1) REFER TO PLAN CERTIFIED BY DOUGLAS A. SEAMONE, NSLS (#265), REGISTRY REFERENCE No. P4439. 2) REFER TO PLAN CERTIFIED BY MICHAEL McKENNA, NSLS (#575), REGISTRY REFERENCE No. P11348.

1) THE DESIGNATIONS LOT "2025", PARCEL "A" AND LOT "2025A" ORIGINATE WITH THIS PLAN. 2) LOT "2025A" AND PID 55279061, REMAINING LANDS OF 3290012 NOVA SCOTIA LIMITED, ARE SERVICED BY MUNICIPAL SEWER AND WATER.

COORDINATE SYSTEM INFORMATION

GNSS SURVEY TYPE: NRTK SOURCE: SMARTNET HORIZONTAL DATUM: NAD83 (CSRS) EPOCH: 2010.0 VELOCITY MODEL: V. 7 VERTICAL DATUM: CGVD2013

PROJECTION: 3° MTM | ZONE: 5 | CENTRAL MERIDIAN: 64°30'W

ANNAPOLIS COUNTY, N.S.


PLAN No: 2025-133P


DeWOLFE & MORSE SURVEYING LIMITED


P.O. BOX 520 MIDDLETON

B0S - 1P0


Email: info@demosl.ca

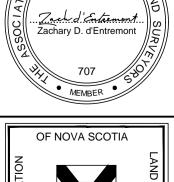

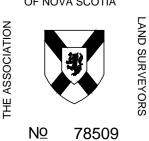

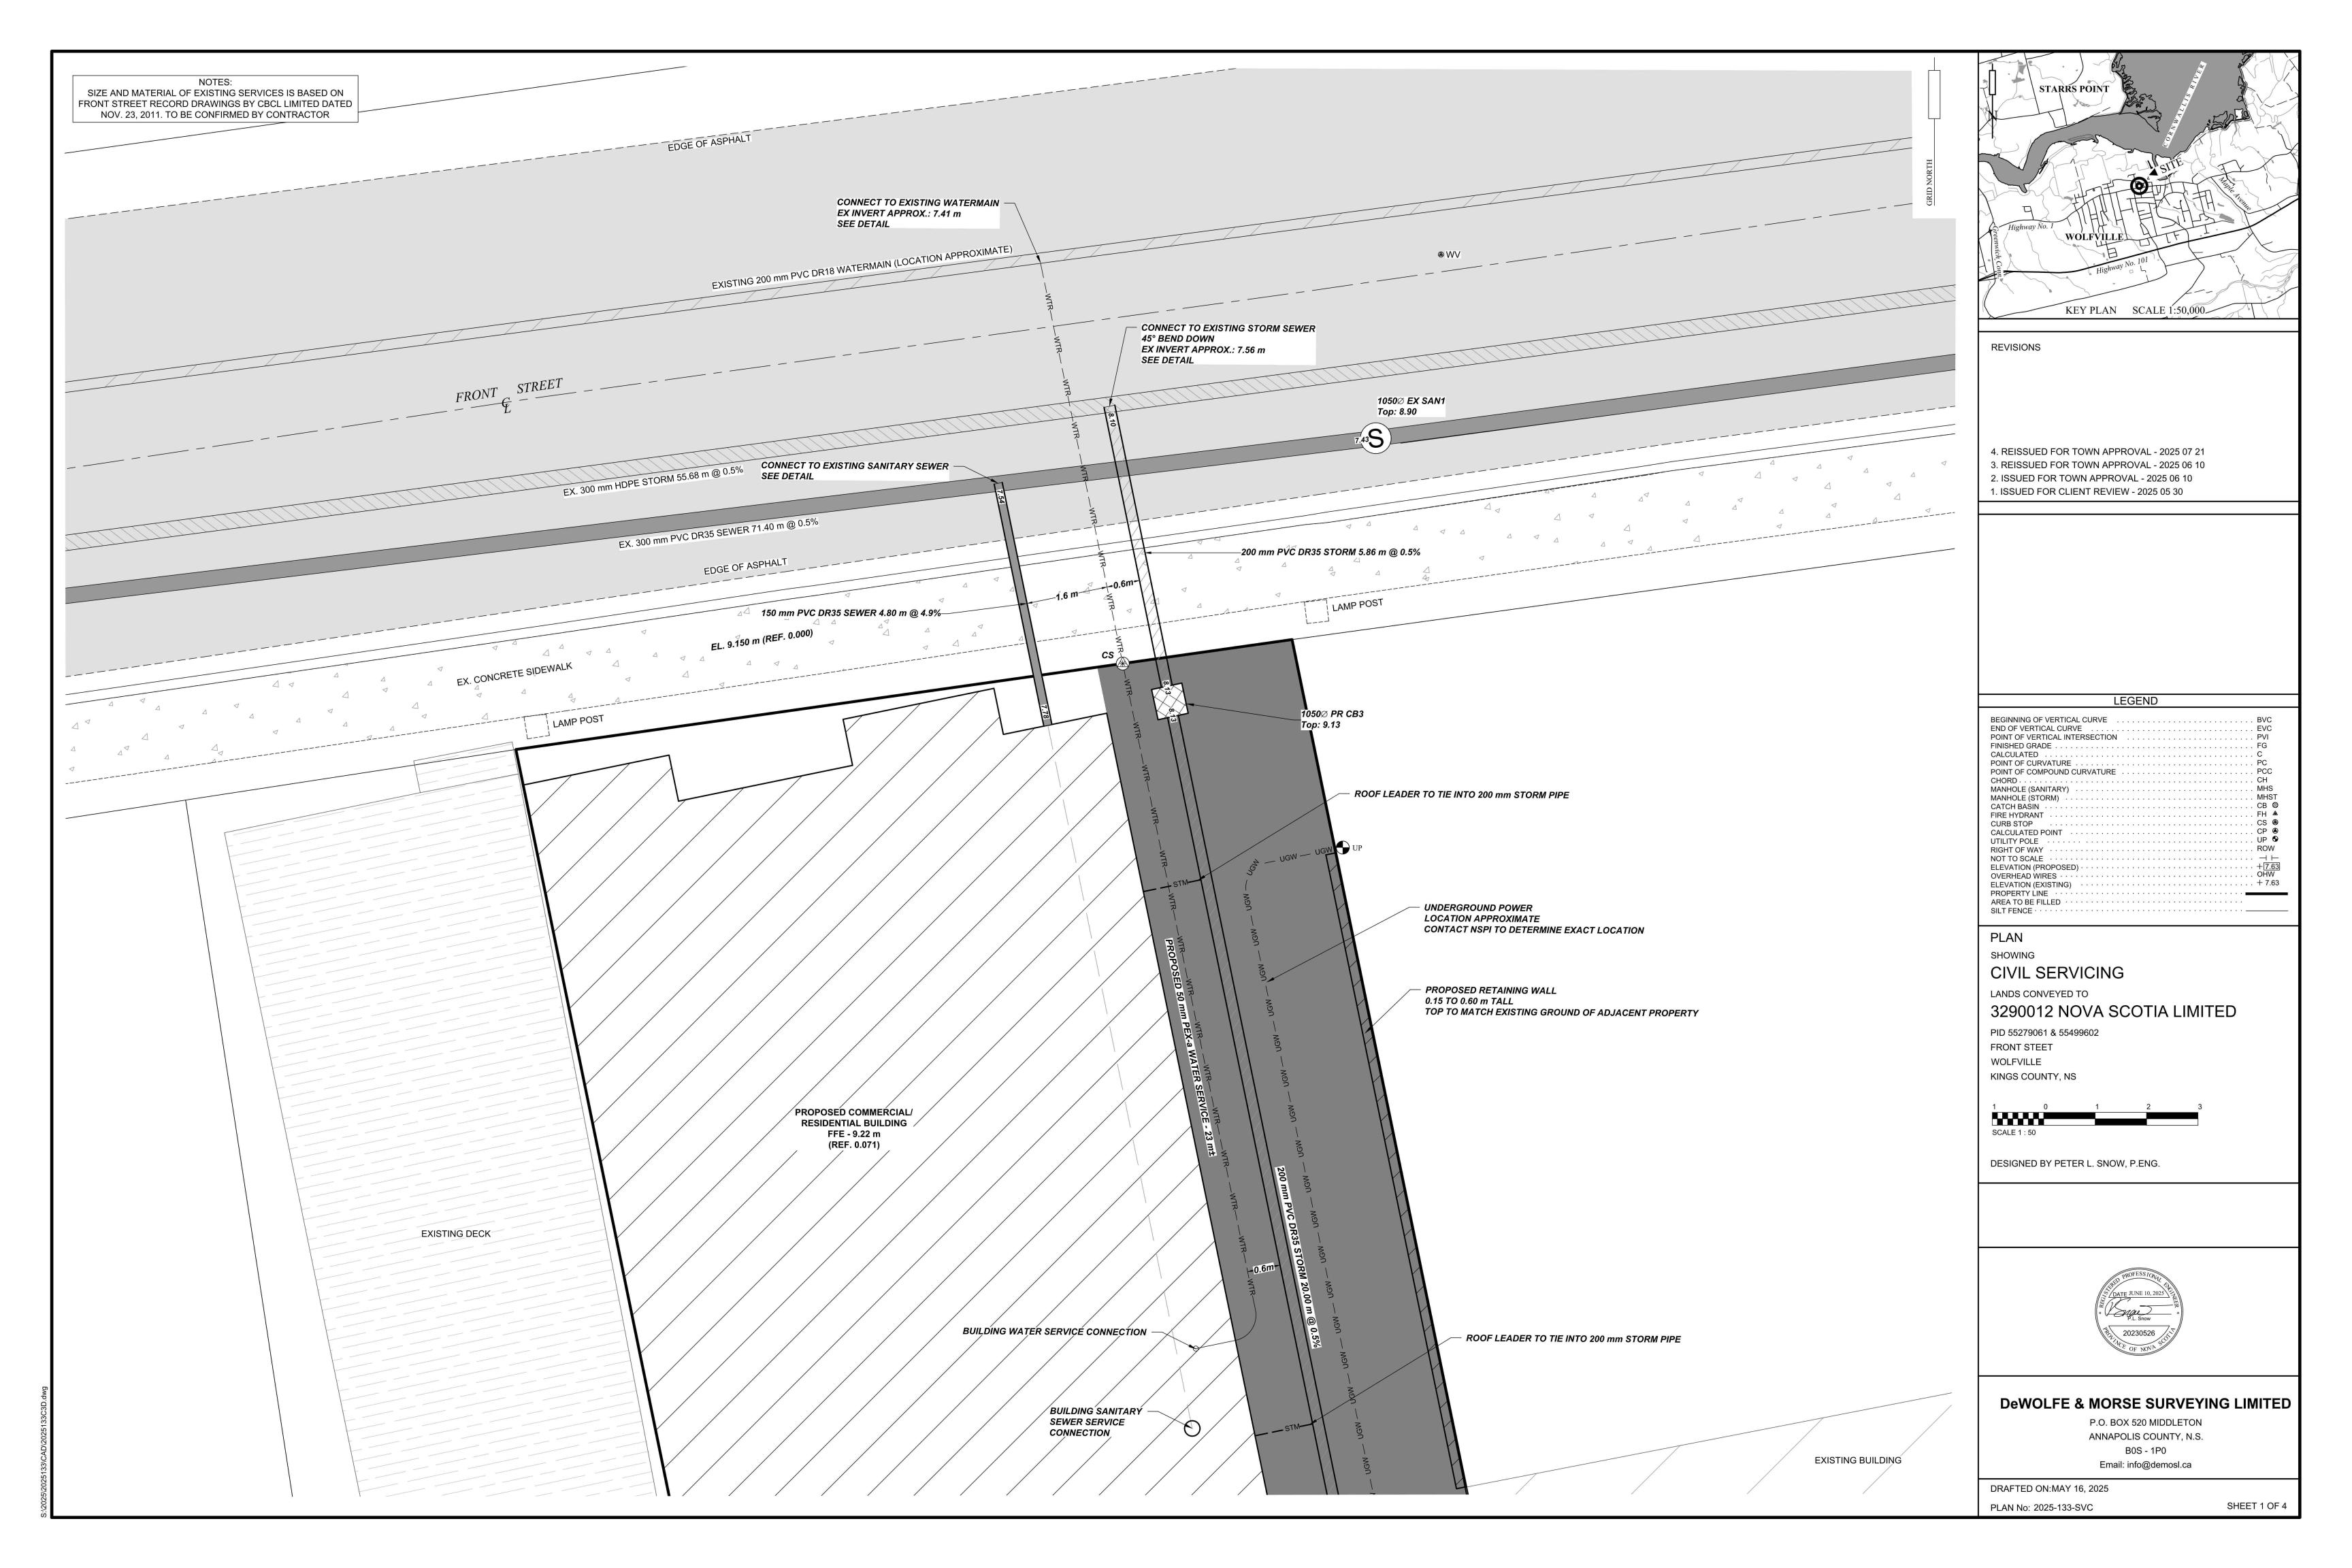



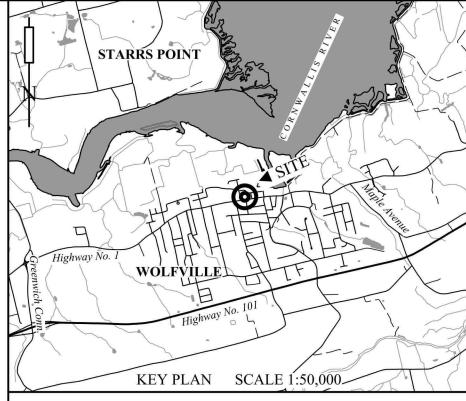

REVISIONS

4. REISSUED FOR TOWN APPROVAL - 2025 07 21 3. REISSUED FOR TOWN APPROVAL - 2025 06 10

1. ISSUED FOR CLIENT REVIEW - 2025 05 30

SHOWING **GRADING**

LANDS CONVEYED TO

3290012 NOVA SCOTIA LIMITED

PID 55279061 & 55499602 FRONT STREET WOLFVILLE KINGS COUNTY, NS



DESIGNED BY PETER L. SNOW, P.ENG.




DeWOLFE & MORSE SURVEYING LIMITED

P.O. BOX 520 MIDDLETON ANNAPOLIS COUNTY, N.S. B0S - 1P0 Email: info@demosl.ca

DRAFTED ON:MAY 16, 2025

SHEET 2 OF 4 PLAN No: 2025-133-GRADING

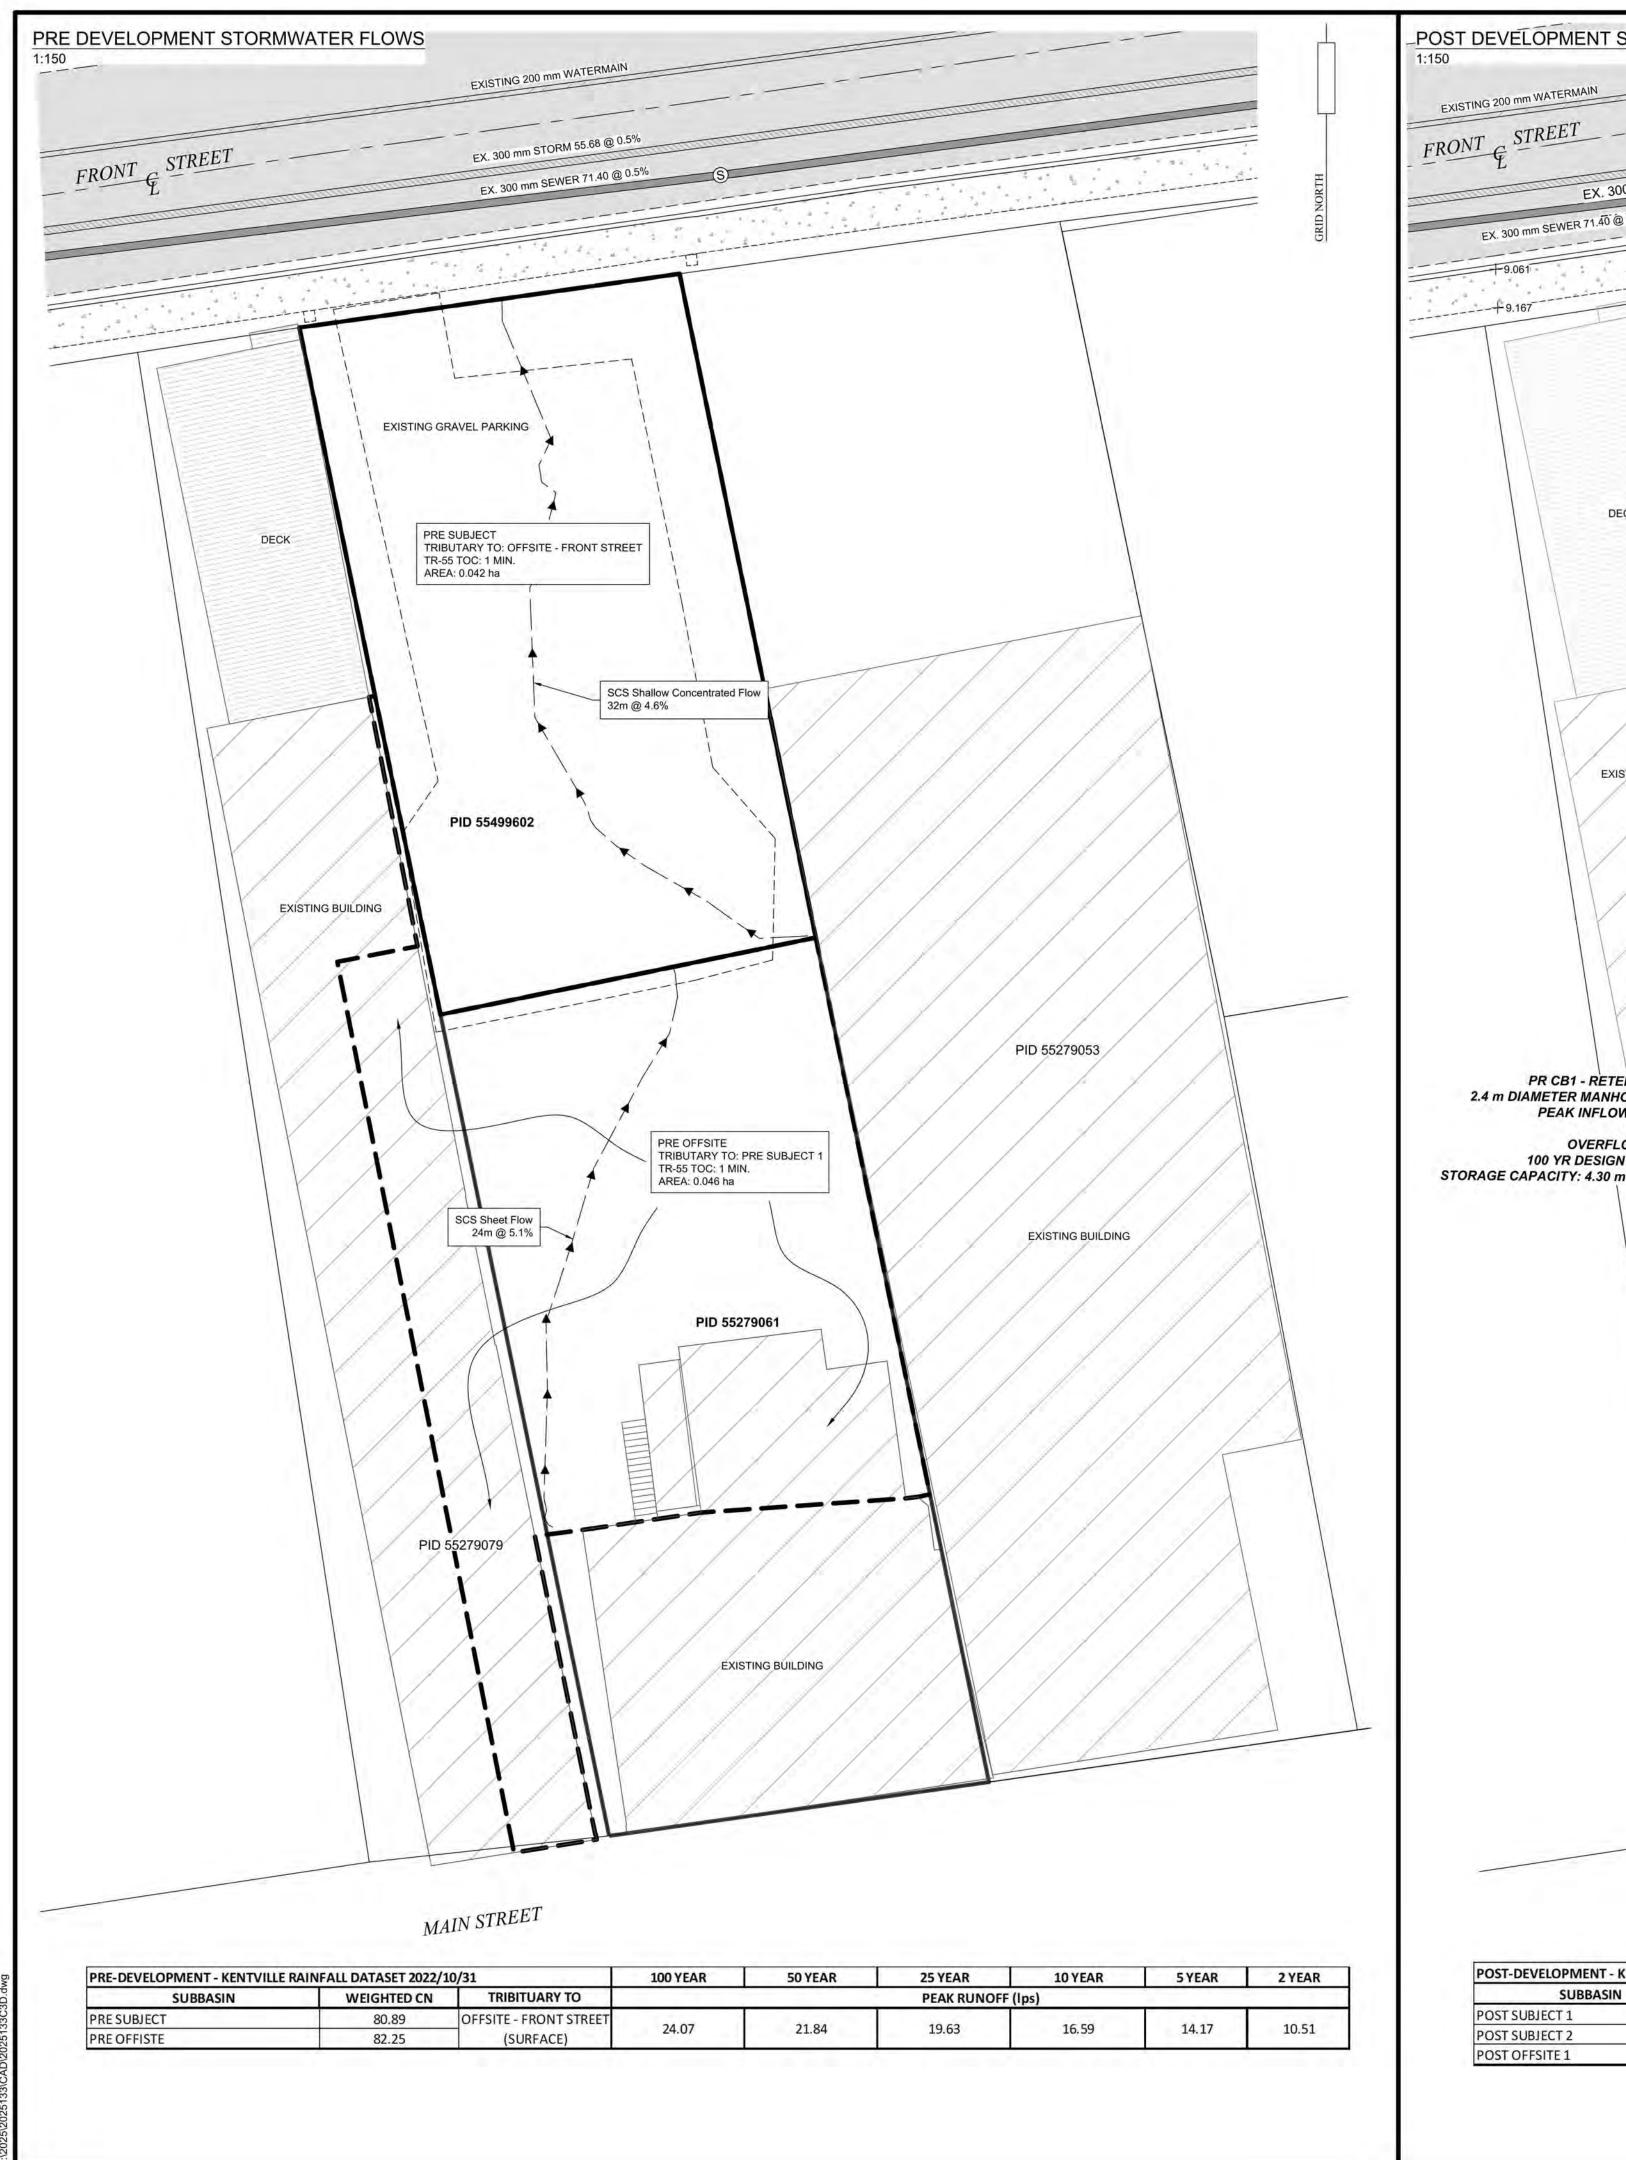



85.95

91.17

89.70

OFFSITE - FRONT STREET

23.80


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REVISIONS

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2. ISSUED FOR TOWN APPROVAL - 2025 06 101. ISSUED FOR CLIENT REVIEW - 2025 05 30

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| SILT FENCE | | | | | | | | | | | | | 2.1 | | | | | | | | |

PLAN

SHOWING

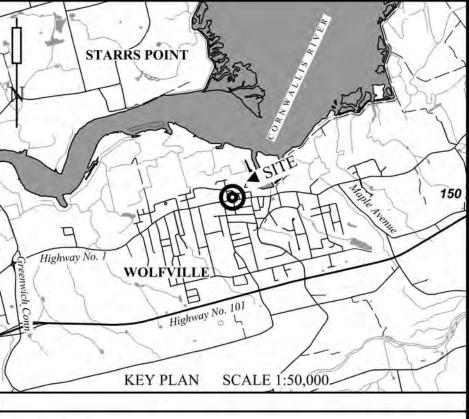PRE AND POST DEVELOPMENT STORMWATER PLANS

LANDS CONVEYED TO

3290012 NOVA SCOTIA LIMITED

PID 55279061 & 55499602 FRONT STREET

WOLFVILLE KINGS COUNTY, NS



DESIGNED BY PETER L. SNOW, P.ENG.




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P.O. BOX 520 MIDDLETON
ANNAPOLIS COUNTY, N.S.
B0S - 1P0
Email: info@demosl.ca

DRAFTED ON:MAY 16, 2025

PLAN No: 2025-133-PRE & POST

SHEET 3 OF 4



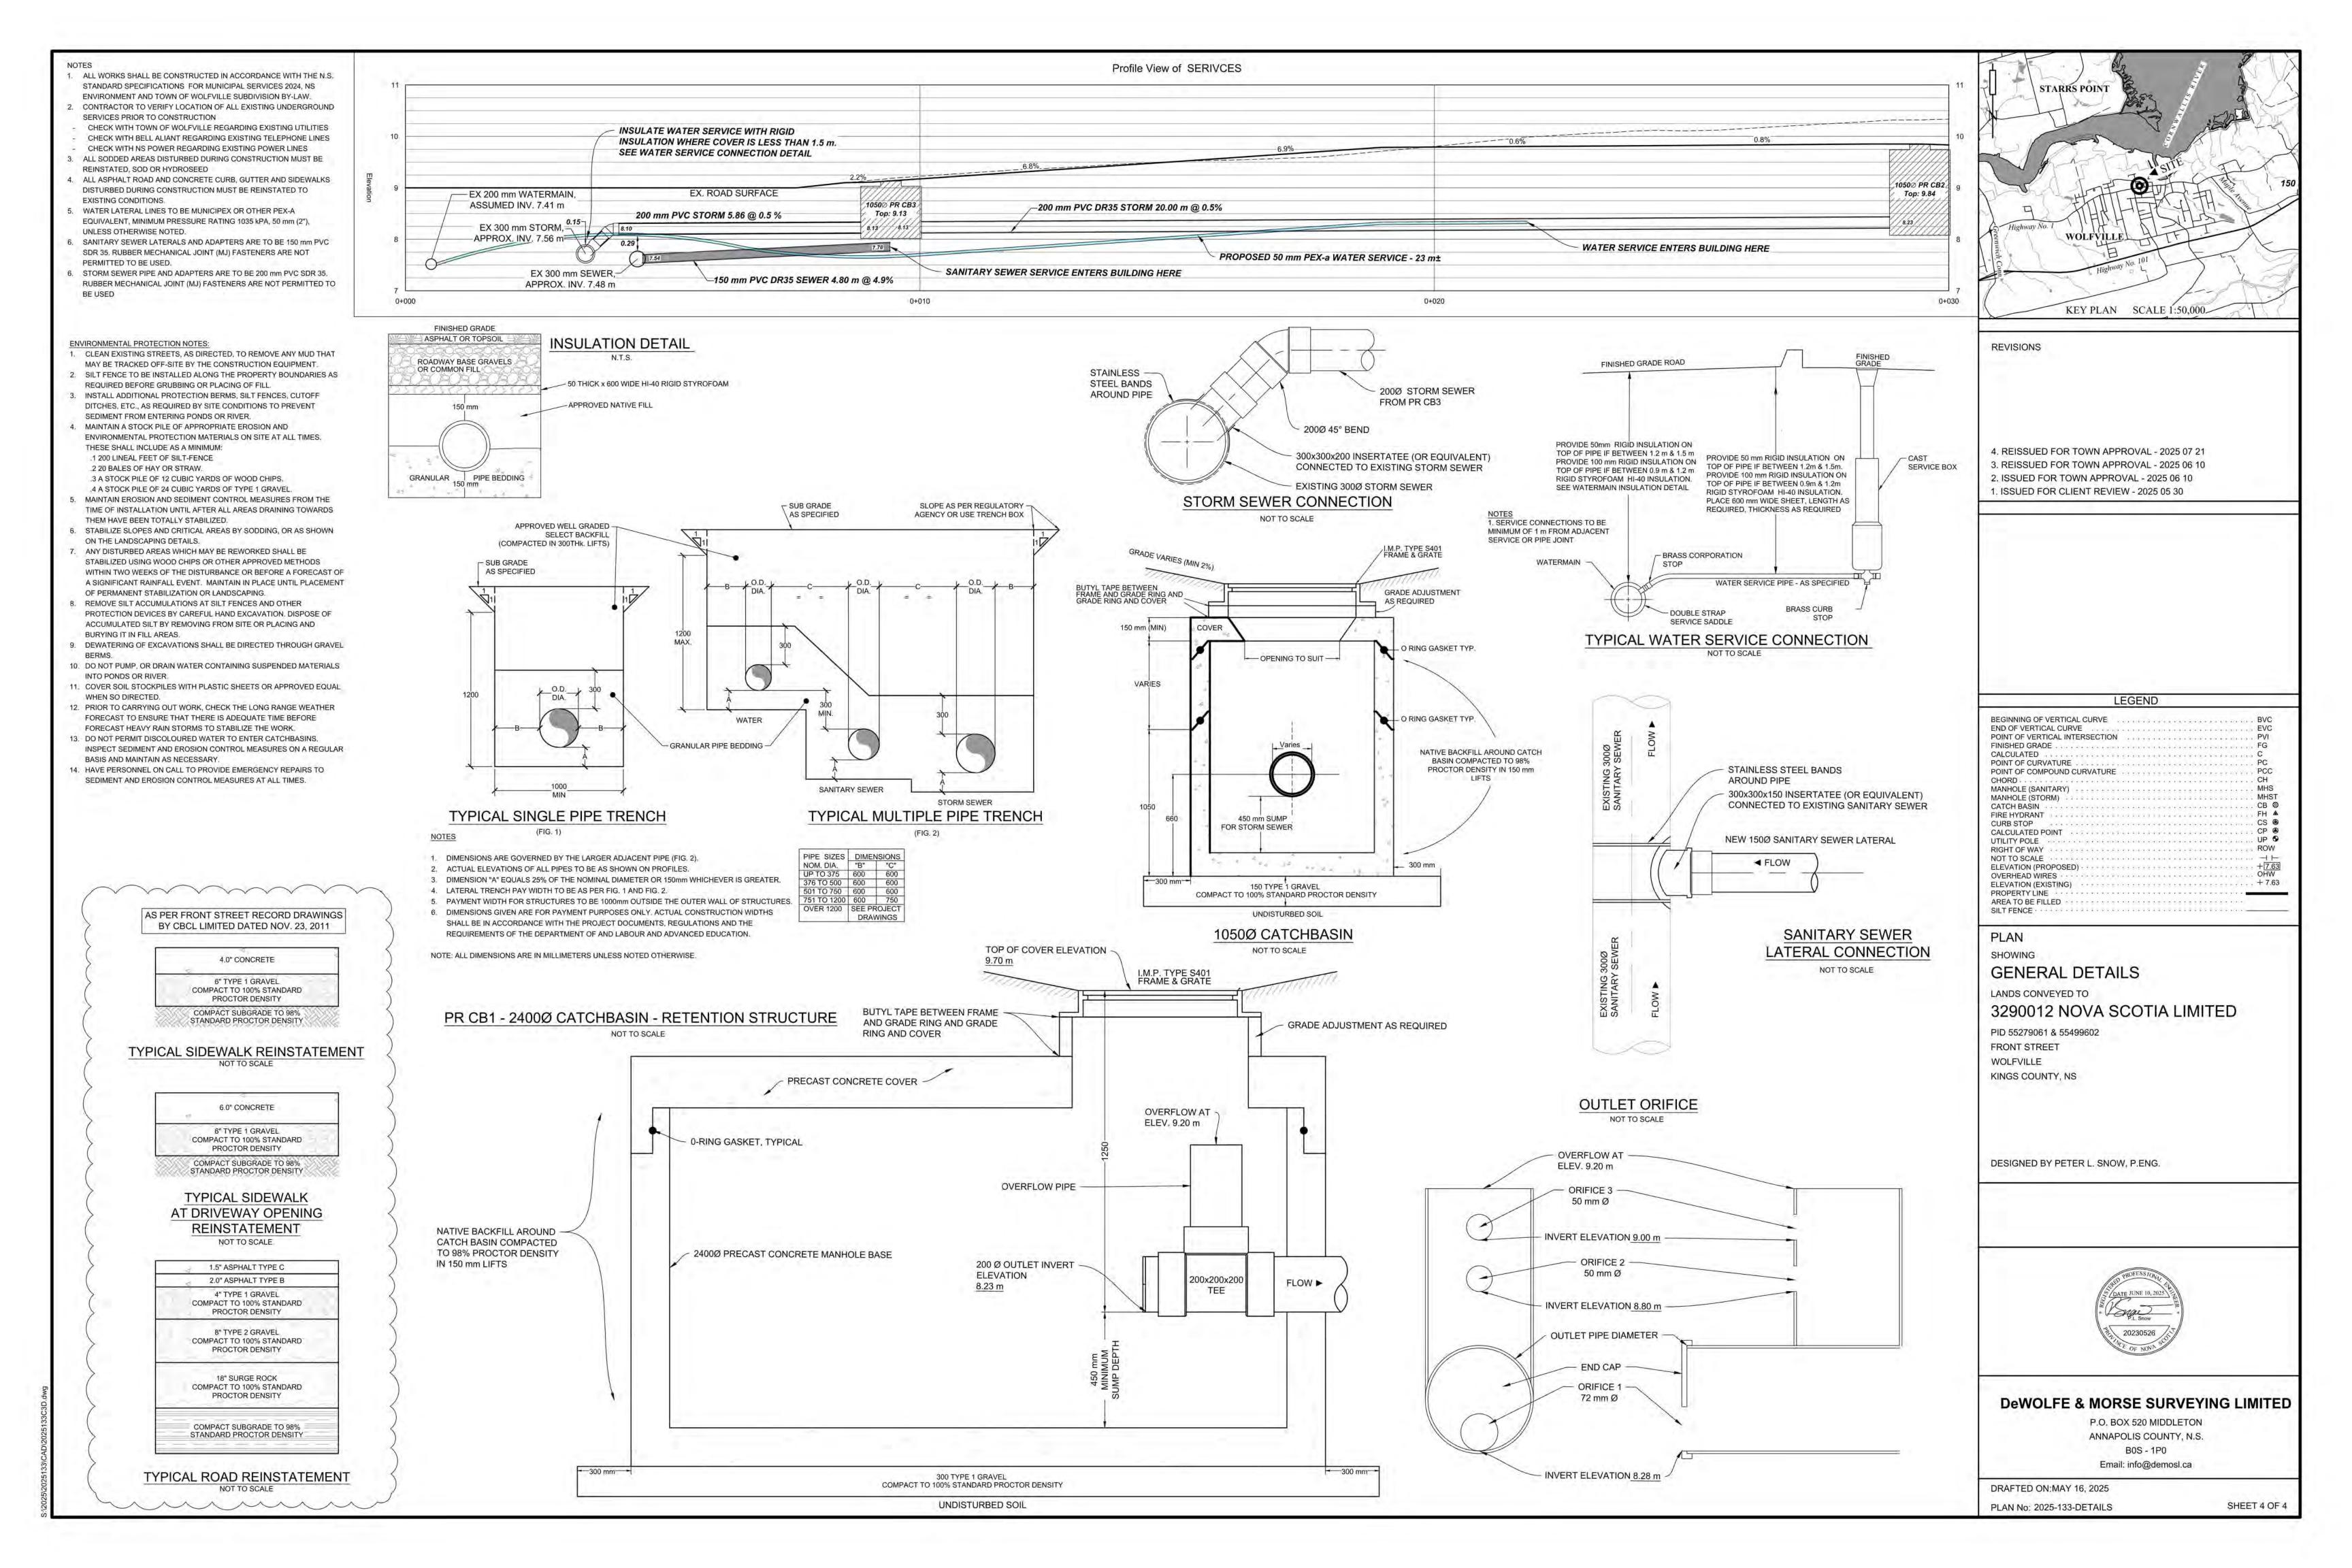

Project: Front Street Apartments

Project Number: 2023-389-01

Design Brief

Submitted to Marcia Elliott, Development Officer

The project program called for one or two small commercial spaces open to the street, and five residential dwelling units. One 'nano' sized studio is located on the ground floor level at the back of the building. Four units are located on the upper floor accessed by the Front Street entrance. Two of the upper units are two bedrooms and two of the units are studio apartments. This provides a mix of dwelling types located within a walkable downtown.

The project is an infill development that begins to create a commercial street wall on Front Street. It is hoped that more infill development will follow to create an active walkable commercial street environment.

The building is situated at the front lot line to promote accessible commercial activity. The ground floor commercial space has a high percentage of glazing to accommodate the commercial activity. The upper floors have residential dwelling units to promote a walkable lifestyle.

The cladding materials are durable, brick on the ground floor, with vertical board & batten style steel siding on the upper two levels. The style of the building is thoroughly modern, but the traditional red brick colour recalls other commercial buildings in town. The change of material for the upper two floors reduces the scale of the building.

The required parking is tucked behind the building accessed by a laneway to the east side. Although the parking takes up much of the space of the courtyard between the new building and the existing Main Street building, space has been maintained for the continued use of a courtyard patio of the microbrewery business on Main Street.

End Document

<u>Site Plan Approval – Criteria Checklist</u>

| Application: | |
|--|--|
| SP-005-2025 – Lot 2025A Front Street – Cor LUB Reference | mmercial/Residential Building Staff Comments |
| 2.10 Submission Requirements | Application requirements met. |
| 2.12 Submission requirements | Application requirements met. |
| Zone Standards : | |
| Part 19 Core Commercial (C-1) zone | Zone standards for setbacks, lot coverage, etc. as per LUB 19.5 have been met. |
| Permitted Use Table 18.1 and 18.2 | Permits mixed use commercial/residential buildings. Five dwelling units – entrance to the ground floor unit is more than 15m from streetline. |
| Design Guideline Areas 18.2 (1) | New 2-3 storey buildings subject to Site Plan Approval. |
| Part 6 Parking: Parking is calculated using table 6.2 • 5 units = 5 spaces required • 114sqm commercial space = 3 | 9 spaces shown on plan (4 spaces on property, 5 on adjacent property through existing access easement). Changes are proposed to the |
| spaces required. | parking requirement for the C-1 zone, therefore the parking allotment will be reviewed at time of occupancy to be compliant with LUB requirements. |
| Bicycle parking | Bicycle parking to be installed as per LUB 6.7. |
| EV parking/charging | Parking area to be designed to be "EV ready" to be able to add an EV charging station if needed. |
| Site Plan Approval Requirements: | Staff Comments |
| LUB 18.3 | |
| 1. The location of new structures on the lot shall minimize negative impacts on the surrounding neighbourhood, including noise, dust, fumes, lighting, shadows, or other nuisance or inconvenience to neighbouring properties; | Proposed new building is not expected to create any negative impacts to neighbouring properties. |
| The location of off-street parking and loading facilities shall minimize negative impacts on the surrounding | Negative impacts are not anticipated. |

| | neighbourhood, including traffic, noise, dust, fumes, lighting, or other nuisance or inconvenience to neighbouring properties; | |
|----|--|---|
| 3. | The location, number and width of driveways are designed to prevent traffic, noise, dust, fumes, congestion, or other nuisance and inconvenience in the area and minimize negative impacts on the surrounding neighbourhood; | Negative impacts are not anticipated. |
| 4. | The type, location, and height of walls, fences, hedges, trees, shrubs, ground cover or other landscaping elements which is necessary to protect and minimize negative land use impact on neighbouring properties; | N/A – The lot is intended to be fully hardscaped. |
| 5. | Existing vegetation shall be retained where the vegetation is healthy and helps to minimize negative impacts on the surrounding neighborhood; | Existing trees along east property line will be retained if possible. |
| 6. | The location of pedestrian walkways, and/or related infrastructure, shall be provided to link public sidewalks and parking areas to entrances of all primary buildings; | Pedestrian links shall be provided along driveway. |
| 7. | The type and location of outdoor lighting is designed to light the structure, driveways and pedestrian infrastructure, but shall not be directed onto neighbouring properties; | Any new lighting installed will be assessed to ensure compliance with the LUB. |
| 8. | The location of facilities for the storage of solid waste provides for maximum separation from residential development and public areas; | Solid waste storage will be assessed to ensure maximum separation from public areas. |
| 9. | The location of all existing easements shall be identified; | Access easement to PID 55279061 shown on survey plan. |
| 10 | The grading or alteration in elevation or contour of the land shall minimize undue erosion and/or sedimentation, and other negative impacts on neighbouring properties; | Alterations to land levels shall be designed in compliance with Stormwater Management Guidelines. |

| 11. The management of storm and surface water is addressed, and associated plans are approved by the Town Engineer; | The application has been reviewed and approved by the Town Engineer. |
|--|--|
| 12. The type, location number and size of signs or sign structures do not negatively alter the appearance of the streetscape or neighbourhood; | Any new signage installed will be assessed to ensure compliance with the LUB. |
| 13. All signage shall be designed and constructed according to the signage requirements listed in Part 7; | Any new signage installed will be assessed to ensure compliance with the LUB. |
| 14. Developments located in a Design Guidelines Area shall adhere to the design guidelines listed in Schedule "F" Town of Wolfville Design Guidelines. Input from the Design Review Committee may be required. | This property is located within the Core Commercial Design Guidelines area. The building's design responds to the Design Guidelines and has been reviewed by the Design Review Committee. |
| 15. The Development Officer may vary any of the prescriptive dimensional requirements by up to 10 percent of the requirements to allow some flexibility to accommodate physical anomalies of a site, so long as the intent of the particular requirement is not compromised. | No variances are anticipated at time of review. |