

- 5. REISSUED FOR SITE PLAN APPROVAL OCTOBER 10, 2025
- 4. REISSUED FOR SITE PLAN APPROVAL SEPTEMBER 29, 2025
- 3. REISSUED FOR SITE PLAN APPROVAL FEBRUARY 11, 2025
- 1. ISSUED FOR CLIENT REVIEW DECEMBER 19, 2024

CONTROL TABLE MTM ZONE 5, NAD 83(CSRS) (2010.0 V7)

EASTING ELEV. DESCRIPTION ACS 250001 4991038.243 25489680.532 45.182 (PUBLISHED)

L	Е	G	Е	Ν

BEGINNING OF VERTICAL CURVE	BVC
END OF VERTICAL CURVE	EVC
POINT OF VERTICAL INTERSECTION	PVI
FINISHED GRADE	FG
CALCULATED	C
POINT OF CURVATURE	PC
POINT OF COMPOUND CURVATURE	
CHORD	
MANHOLE (SANITARY)	
MANHOLE (STORM)	
CATCH BASIN	
SILUICE BOX / CATCH PIT	
FIRE HYDRANT	
WATER VALVE	WV ( <del>&amp;</del> )
CALCULATED POINT	CP
UTILITY POLE	UP 👽
RIGHT OF WAY	
NOT TO SCALE	
ELEVATION (FINISHED GRADE) · · · · · · · · · · · · · · · · · · ·	· · · · · · · · + [7.63]
OVERHEAD WIRES	
ELEVATION (EXISTING)	+ 7.63
PROPERTY LINE	
AREA TO BE FILLED	
SILT FENCE · · · · · · · · · · · · · · · · · · ·	

### HIGHLAND AVENUE DEVELOPMENT

# KENT FIELDS ESTATES LTD.

HIGHLAND AVENUE, WOLFVILLE



PROFILE SCALE- VERTICAL 1:30

DESIGNED BY PETER L. SNOW, P.ENG.





### **DeWOLFE & MORSE SURVEYING LIMITED**

P.O. BOX 520 MIDDLETON ANNAPOLIS COUNTY, N.S. B0S - 1P0 Email: info@demosl.ca

SHEET 3 of 7

DRAFTED ON: FEBRUARY 12, 2024

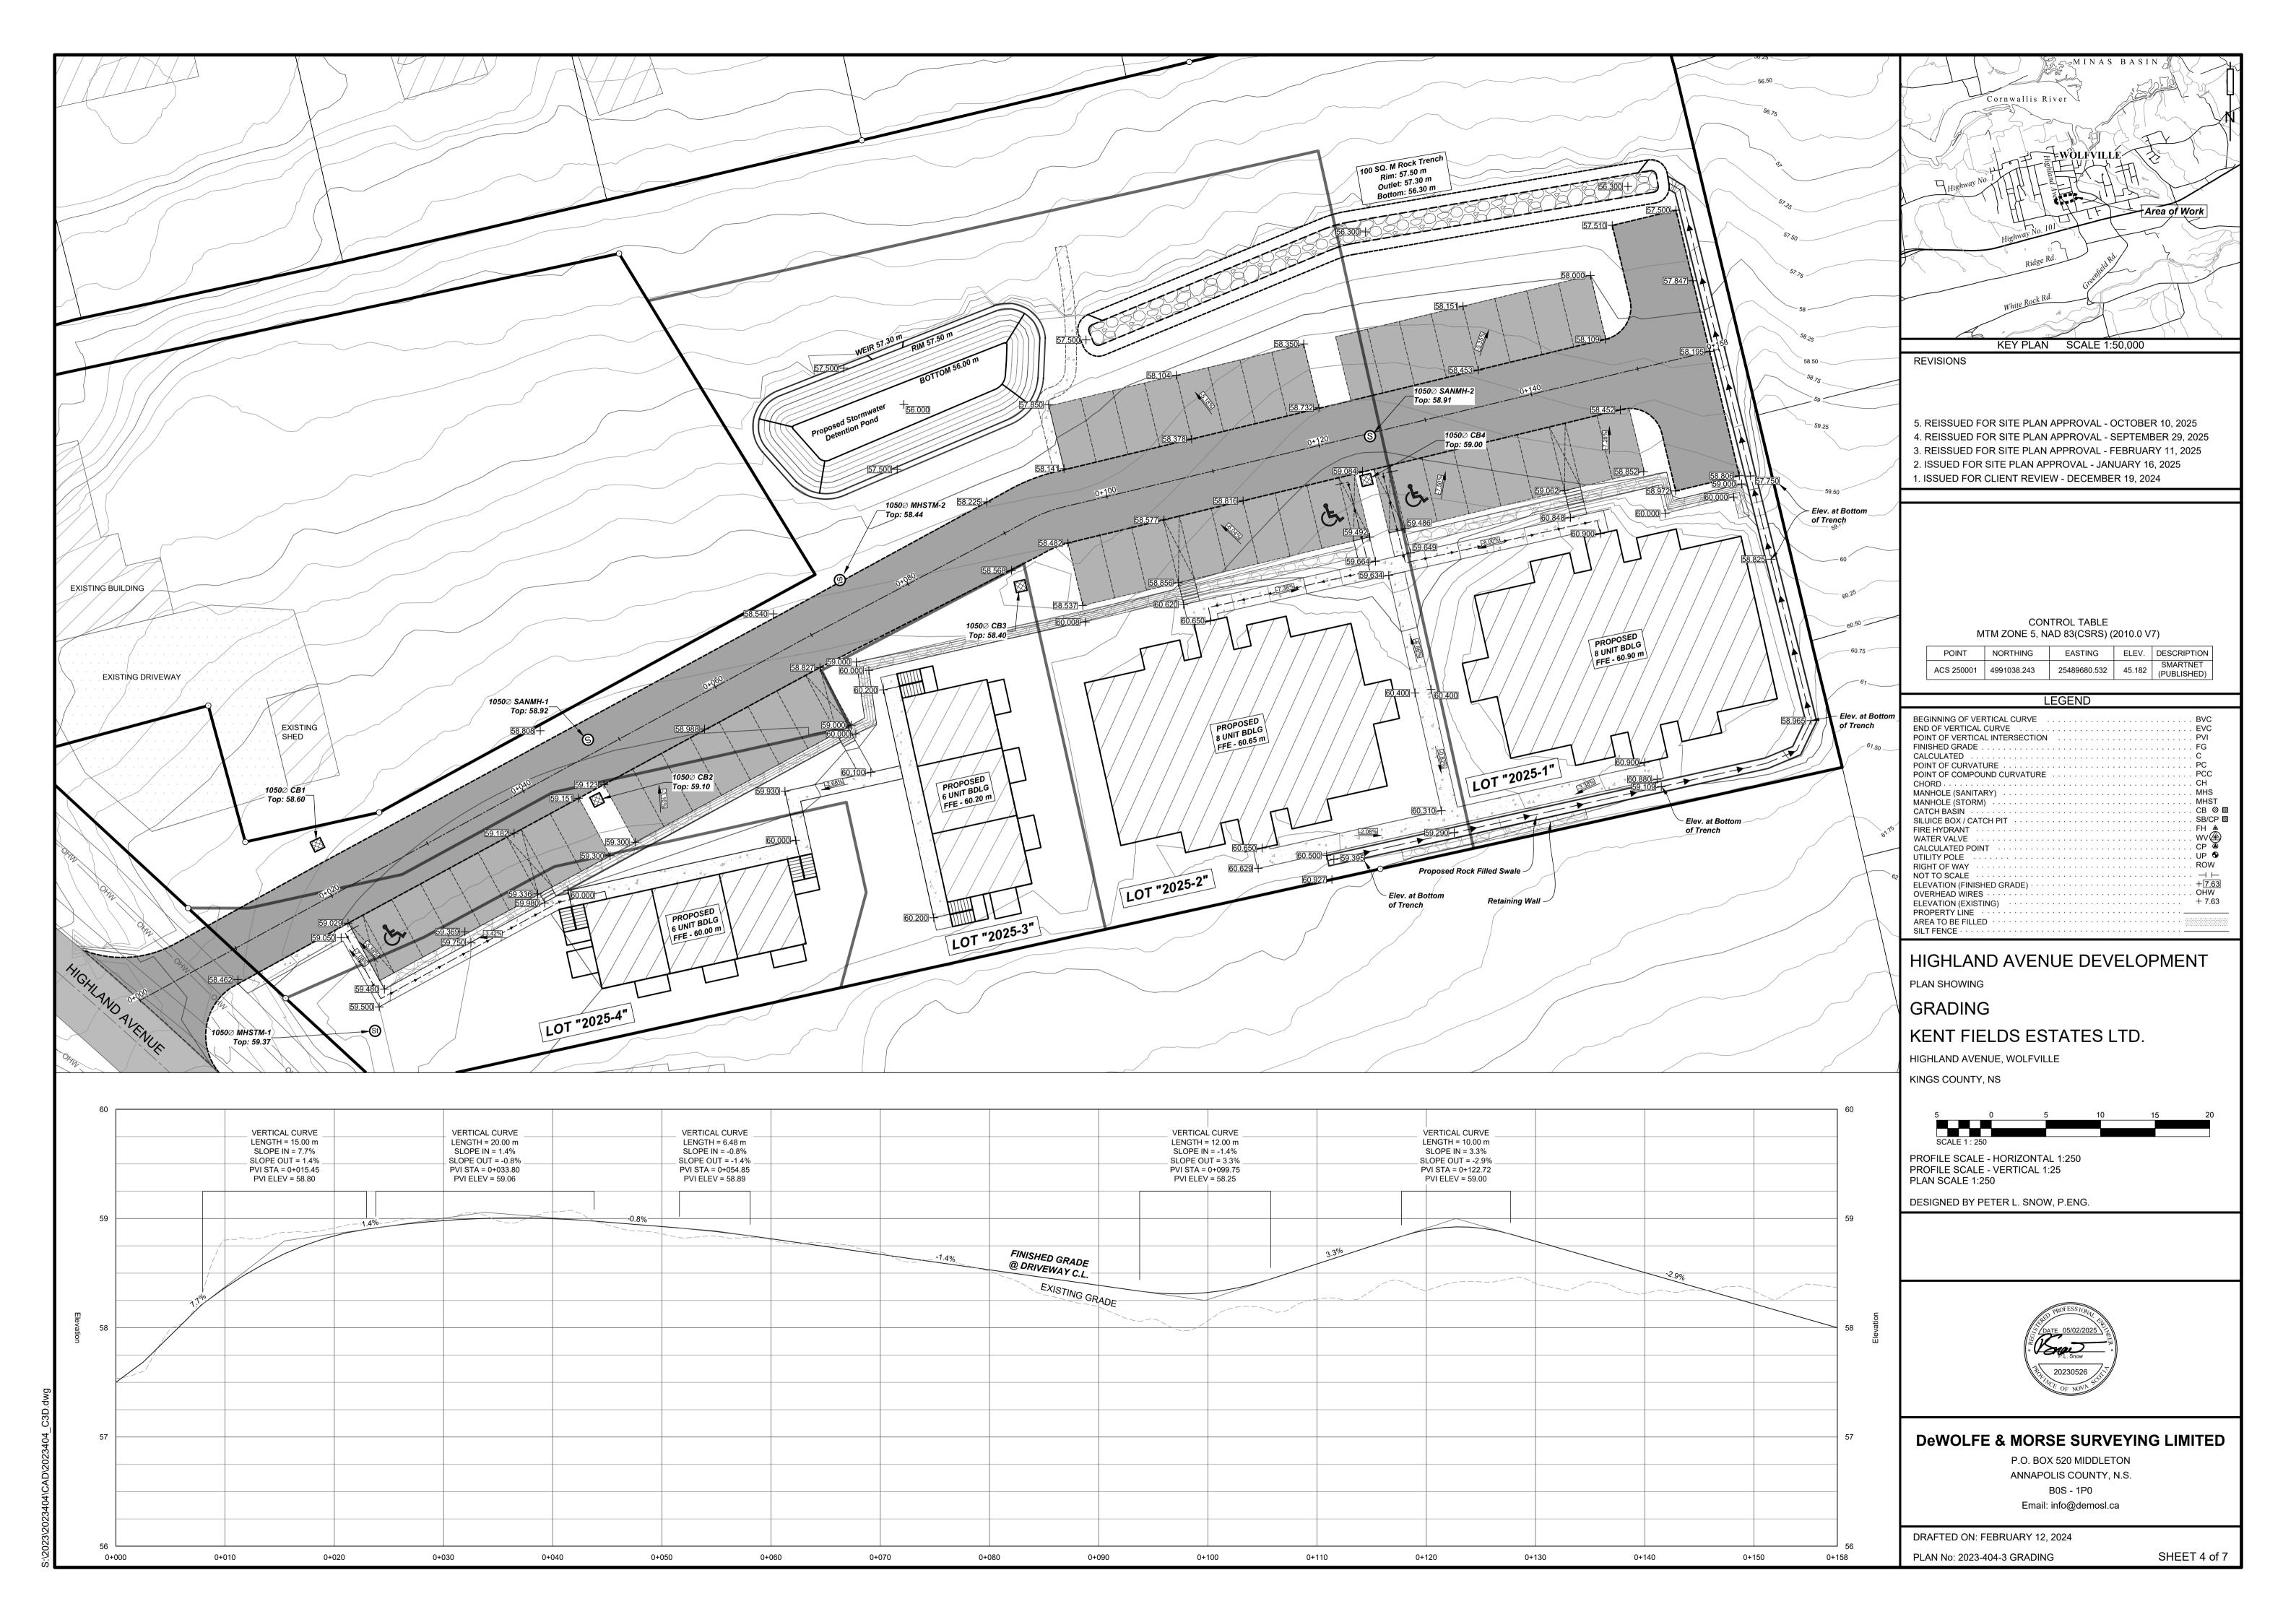

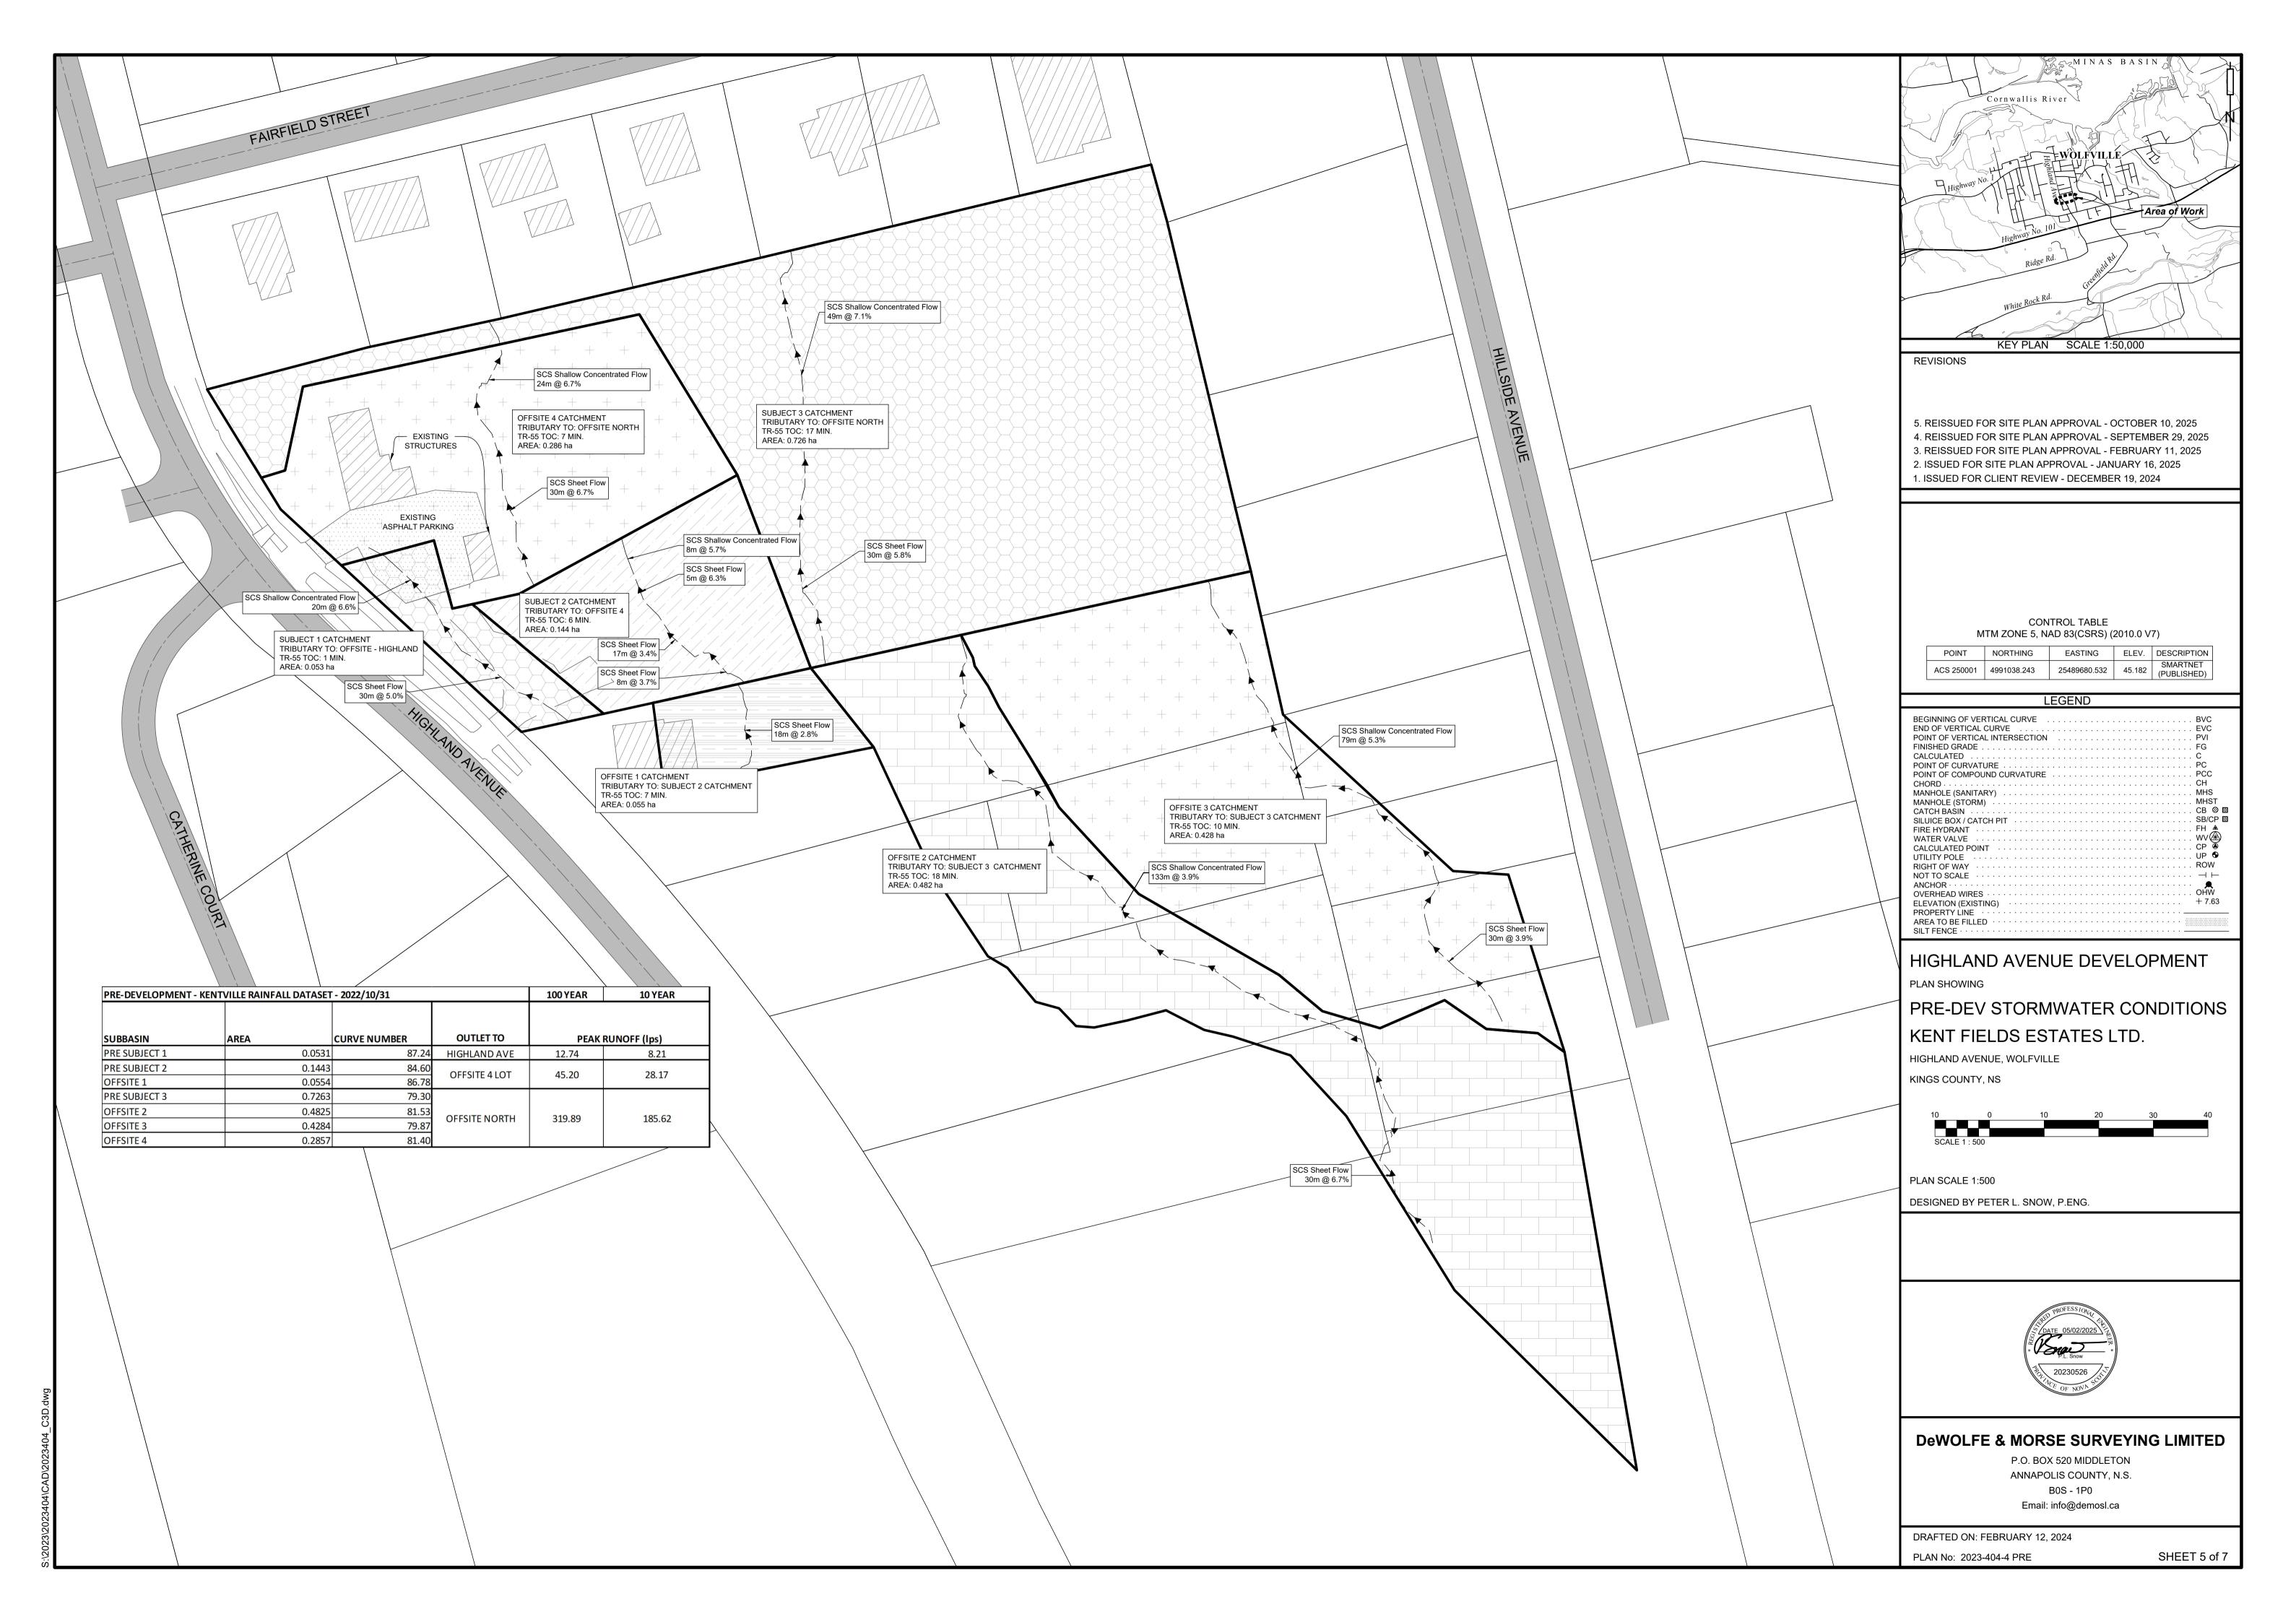



0.59 0.94 125.47

0.13 0.13

PIPE 7

CB 4

33.13

CB3

57.63

57.30 1.0000 300.000

0.0100

15.720

**†WÖLFVILLE** Area of Work

Cornwallis River

KEY PLAN SCALE 1:50,000

- 5. REISSUED FOR SITE PLAN APPROVAL OCTOBER 10, 2025
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- 3. REISSUED FOR SITE PLAN APPROVAL FEBRUARY 11, 2025 2. ISSUED FOR SITE PLAN APPROVAL - JANUARY 16, 2025
- 1. ISSUED FOR CLIENT REVIEW DECEMBER 19, 2024

CONTROL TABLE

М	TM ZONE 5, NA	AD 83(CSRS) (	2010.0 V	7)
POINT	NORTHING	EASTING	ELEV.	DESCRIPTION
ACS 250001	4991038.243	25489680.532	45.182	SMARTNET (PUBLISHED)

#### LEGEND

DECUMBING OF VERTICAL CURVE
BEGINNING OF VERTICAL CURVE BVC
END OF VERTICAL CURVE
POINT OF VERTICAL INTERSECTION
FINISHED GRADE
CALCULATED
POINT OF CURVATURE
POINT OF COMPOUND CURVATURE
CHORD
MANHOLE (SANITARY) MHS
MANHOLE (STORM)
CATCH BASIN
SILUICE BOX / CATCH PIT SB/CP 🖾
FIRE HYDRANT FH
WATER VALVE WV
CALCULATED POINT CP
CALCULATED POINT
UTILITY POLE UP •
RIGHT OF WAY ROW
NOT TO SCALE · · · · · · · · · · · · · · · · · · ·
ANCHOR · · · · · · · · · · ·
OVERHEAD WIRES · · · · · · · · OHW
ELEVATION (EXISTING) + 7.63
PROPERTY LINE
THOI EITH EITE
AREA TO BE FILLED
SILT FENCE · · · · · · · · · · · · · · · · · · ·

### HIGHLAND AVENUE DEVELOPMENT

### POST-DEV STORMWATER CONDITIONS

### KENT FIELDS ESTATES LTD.

HIGHLAND AVENUE, WOLFVILLE

KINGS COUNTY, NS



PLAN SCALE 1:500

DESIGNED BY PETER L. SNOW, P.ENG.




### **DeWOLFE & MORSE SURVEYING LIMITED**

P.O. BOX 520 MIDDLETON ANNAPOLIS COUNTY, N.S. B0S - 1P0 Email: info@demosl.ca

DRAFTED ON: FEBRUARY 12, 2024

PLAN No: 2023-404-5 POST

SHEET 6 of 7

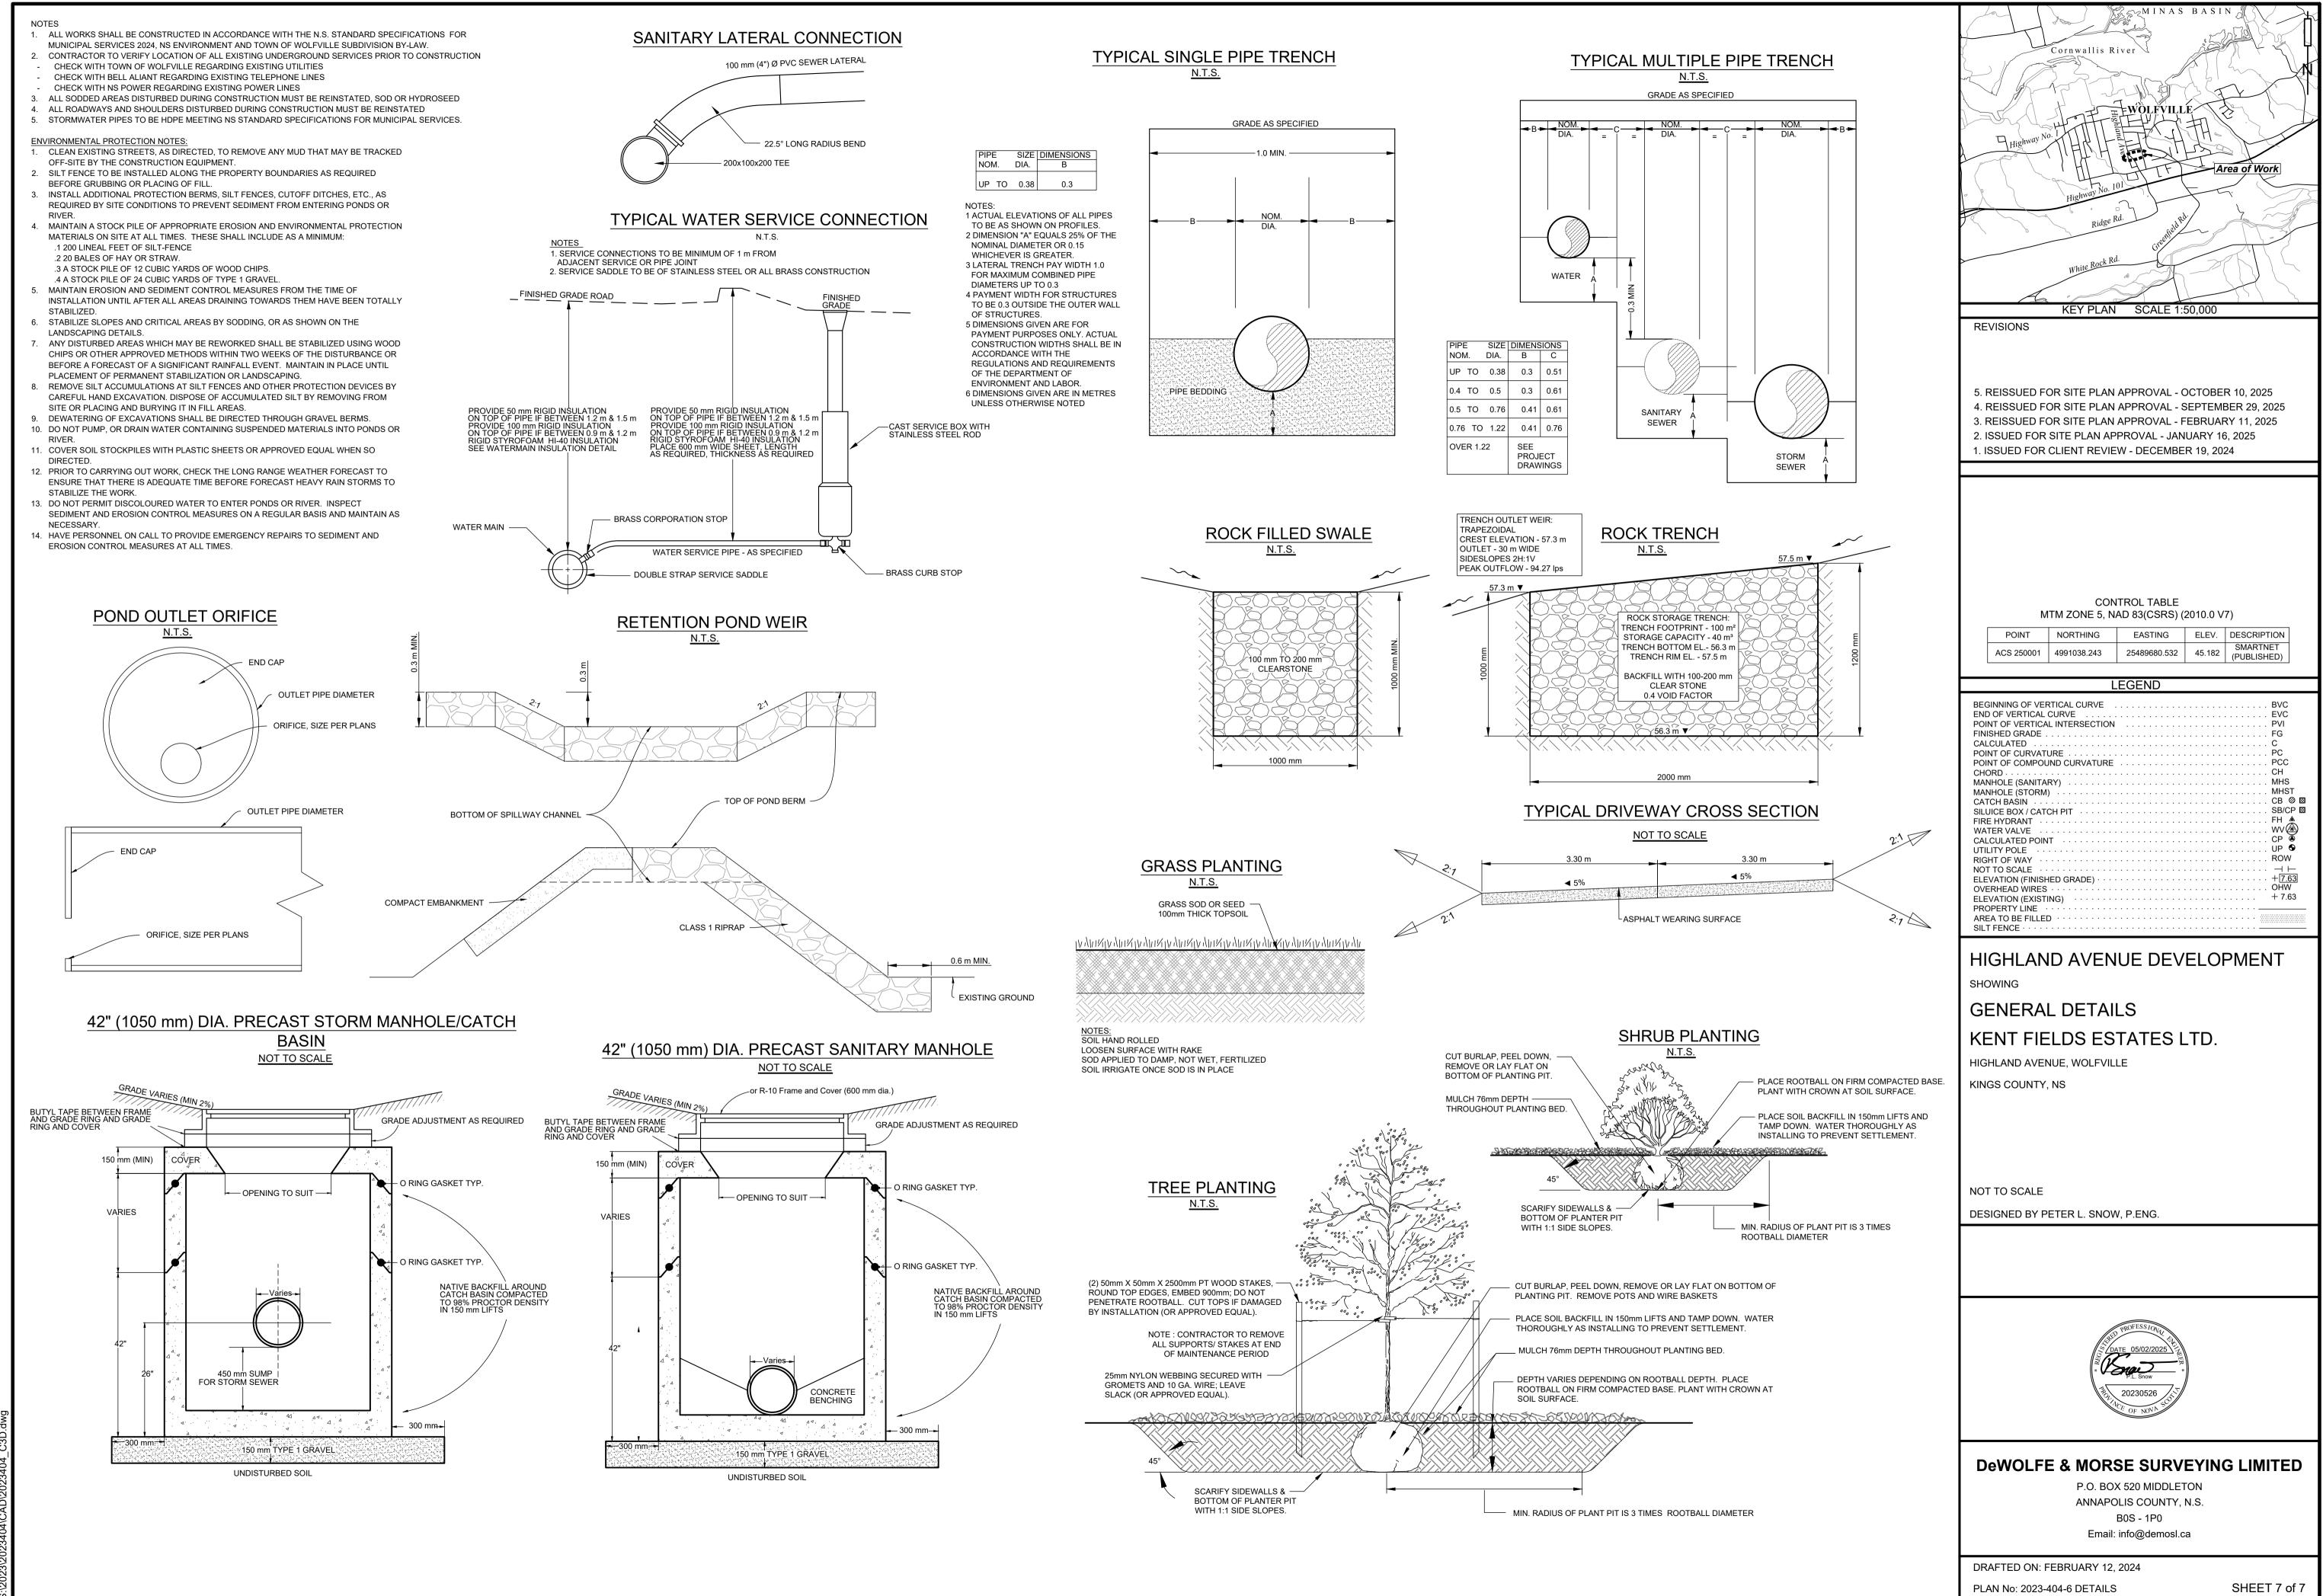

#### <u>Site Plan Approval – Criteria Checklist</u>

**APPLICATION:** 

SP-002-2024 Lots 2025-1, 2025-2, 2025-3, 2025-4 Highland Avenue - 28 units

on Four Lots

**Review Date: February 28, 2025** 

LUB Reference	Staff Comments
2.10 Submission Requirements	Application requirements met.
Zone Standards:	Lot 2025-1 8-unit Building
Part 12 Medium Density Residential (R-3) zone	Lot 2025-2 8-unit Building
Permitted Use Table 8.1	Lot 2025-3 6-unit Building
	Lot 2025-4 6-unit Building
Part 6 Parking Parking is calculated using table 6.1 1.25 spaces per dwelling unit + ½ space for each bedroom in excess of three.	35 spaces required – 45 spaces provided
Site Plan Approval Requirements:	
1. The location of new structures on the lot shall minimize negative impacts on the surrounding neighbourhood, including noise, dust, fumes, lighting, shadows, or other nuisance or inconvenience to neighbouring properties;	No issues identified. Landscape buffering will be put in place to minimize any impacts should they arise.
2. The location of off-street parking and loading facilities shall minimize negative impacts on the surrounding neighbourhood, including traffic, noise, dust, fumes, lighting, or other nuisance or inconvenience to neighbouring properties;	Parking areas are designed in keeping with parking lot standards – Land Use Bylaw section 6.5
3. The location, number and width of driveways are designed to prevent traffic, noise, dust, fumes, congestion, or other nuisance and inconvenience in the area and minimize negative impacts on the surrounding neighbourhood;	One access point for the four lots. Access easements will be required prior to occupancy.

#### <u>Site Plan Approval – Criteria Checklist</u>

	The type, location, and height of walls, fences, hedges, trees, shrubs, ground cover or other landscaping elements which is necessary to protect and minimize negative land use impact on neighbouring properties;	LUB 8.7(2) Abutting Landscape Buffers - Landscape buffer required on the rear and side yards.
	Existing vegetation shall be retained where the vegetation is healthy and helps to minimize negative impacts on the surrounding neighbourhood;	Existing trees and vegetation will be retained where possible.
	The location of pedestrian walkways, and/or related infrastructure, shall be provided to link public sidewalks and parking areas to entrances of all primary buildings;	Proposed walkway and driveway provide linkage to street and amenity areas.
	The type and location of outdoor lighting is designed to light the structure, driveways and pedestrian infrastructure, but shall not be directed onto neighbouring properties;	Any new lighting installed will be assessed to ensure compliance with the LUB.
8.	The location of facilities for the storage of solid waste provides for maximum separation from residential development and public areas;	Solid waste storage to be screened.
9.	The location of all existing easements shall be identified;	Proposed access and parking easements drawings provided. Easements will be finalized prior to occupancy.
10.	The grading or alteration in elevation or contour of the land shall minimize undue erosion and/or sedimentation, and other negative impacts on neighbouring properties;	Alterations to land levels, etc. have been designed in compliance with the Stormwater Management Guidelines and approved by the Town Engineer.
11.	The management of storm and surface water is addressed, and associated plans are approved by the Town Engineer;	The application has been reviewed and approved by the Town Engineer.
12.	The type, location number and size of signs or sign structures do not negatively alter the appearance of the streetscape or neighbourhood;	N/A
13.	All signage shall be designed and constructed according to the signage requirements listed in Part 7;	N/A

### <u>Site Plan Approval – Criteria Checklist</u>

14. Developments located in a Design Guidelines Area shall adhere to the design guidelines listed in Schedule "F" Town of Wolfville Design Guidelines. Input from the Design Review Committee may be required.	This property is not located in a Design Guidelines Area.
15. The Development Officer may vary any of the prescriptive dimensional requirements by up to 10 percent of the requirements to allow some flexibility to accommodate physical anomalies of a site, so long as the intent of the particular requirement is not compromised.	No variances are anticipated at time of review.







## PROJECT NAME: KENTFILEDS 8 UNIT APARTMENT PLANS

- A1- FIRST FLOOR
- A2- SECOND FLOOR
- A3- ELEVATIONS
- A4- ELEVATION
- A5- CROSS SECTION
- A6- STAIR SECTION
- A7- DECK CONSTRUCTION
- A8- INTERIOR DIMENSIONS
- A9- ROOF PLAN
- A10- SCHEDULES


- 1. ALL WORK AND MATERIALS SHALL CONFORM TO THE NATIONAL BUILDING CODE AS ADOPTED BY THE PROVINCE OF NOVA SCOTIA & ALL AUTHORITIES HAVING JURISDICTION.
- 2. EXAMINE ALL DRAWINGS & CHECK ALL DIMENSIONS AGAINST SITE CONDITIONS AND REPORT ANY DISCREPANCIES BEFORE PROCEEDING WITH WORK.
- 3. FOUNDATION DESIGN BASED ON A MINIMUM SOIL BEARING CAPACITY OF 3,000 P.S.F.
- 4. ALL FOOTINGS SHALL BEAR ON UNDISTURBED SOIL OR STRUCTURAL FILL HAVING A MINIMUM BEARING CAPACITY OF 3,000 psf.
- 5. SUB-BASE UNDER SLABS ON GRADE SHALL BE COMPACTED TO 100% STANDARD PROCTOR (ASTM D698) MAXIMUM DRY DENSITY AND SHALL 5. BE PLACED ON STRUCTURAL FILL SUB BASE HAVING A MIN. BEARING CAPACITY OF 3,000 P.S.F.
- 6. DESIGN, INSTALL AND MAINTAIN ADEQUATE
  TEMPORARY BRACING AND SHORING OF ALL
  STRUCTURAL ELEMENTS FOR STABILITY AND
  SAFETY WHERE REQUIRED DURING
  CONSTRUCTION IN ACCORDANCE WITH
  REGULATIONS AND AUTHORITIES HAVING
  JURISDICTION.


#### REINFORCED CONCRETE NOTES

- ALL CONCRETE, CONCRETE MATERIAL, FORMS, PRACTICE, ETC. SHALL CONFORM TO CAN/CSA-A23.1-M94 UNLESS NOTED OTHERWISE.
- . MINIMUM COMPRESSIVE STRENGTH OF CONC. AT 28 DAYS SHALL

#### - 4,000 psi FOR INTERIOR FLOOR SLABS

- MATERIALS FOR FLOOR SLAB AS FOLLOWS:
   4,000psi CONCRETE PLACED AT A SLUMP OF 4" TO 5".
- 4. CONCRETE PROTECTIVE COVER FOR REINFORCING STEEL SHALL BE AS FOLLOWS:
- PROVIDE CONTINUOUS SUPERVISION DURING THE PLACEMENT OF CONCRETE TO ENSURE THAT THE REINFORCING STEEL IS MAINTAINED IN ITS CORRECT POSITION.
- 6. ALL REINFORCING STEEL SHALL HAVE A MINIMUM YIELD STRENGTH OF 400 MPa AND CONFORM TO CSA G30.18-M92.
- 7. ALL REINFORCING STEEL SHALL BE DETAILED, FABRICATED, PLACED AND SUPPORTED IN ACCORDANCE WITH "REINFORCING STEEL MANUAL OF STANDARD PRACTICE" BY THE REINFORCING STEEL INSTITUTE OF CANADA FIRST EDITION 1992.
- 8. ALL REINFORCING STEEL TO BE LAPPED A MIN. OF 30 BAR DIAMETERS UNLESS NOTED INCLUDING CORNERS.
- 9. FLOOR SLAB TO HAVE A SMOOTH STEEL TROWEL FINISH.
- 10. ALL CONCRETE TO BE PROTECTED FROM FREEZING OR ANY OTHER DETREMENTAL EFFECTS WHICH MAY BE CAUSED BY WEATHER CONDITIONS.
- 11. SAWCUT CONCRETE SLAB 1/4 OF THE SLAB THICKNESS WHERE INDICATED ON THE DRAWING WITH EARLY ENTRY SAW. FILL SAWCUT JOINTS WITH JOINT FILLER.

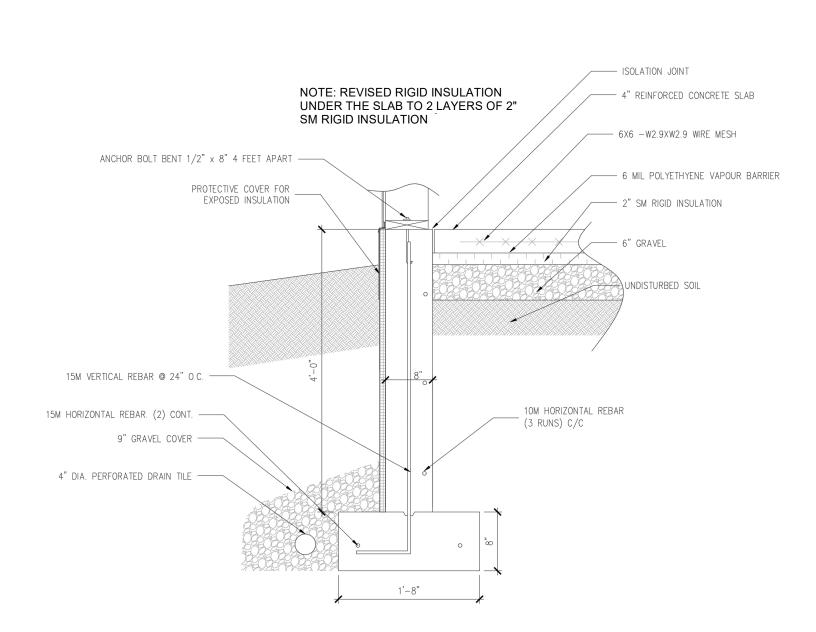

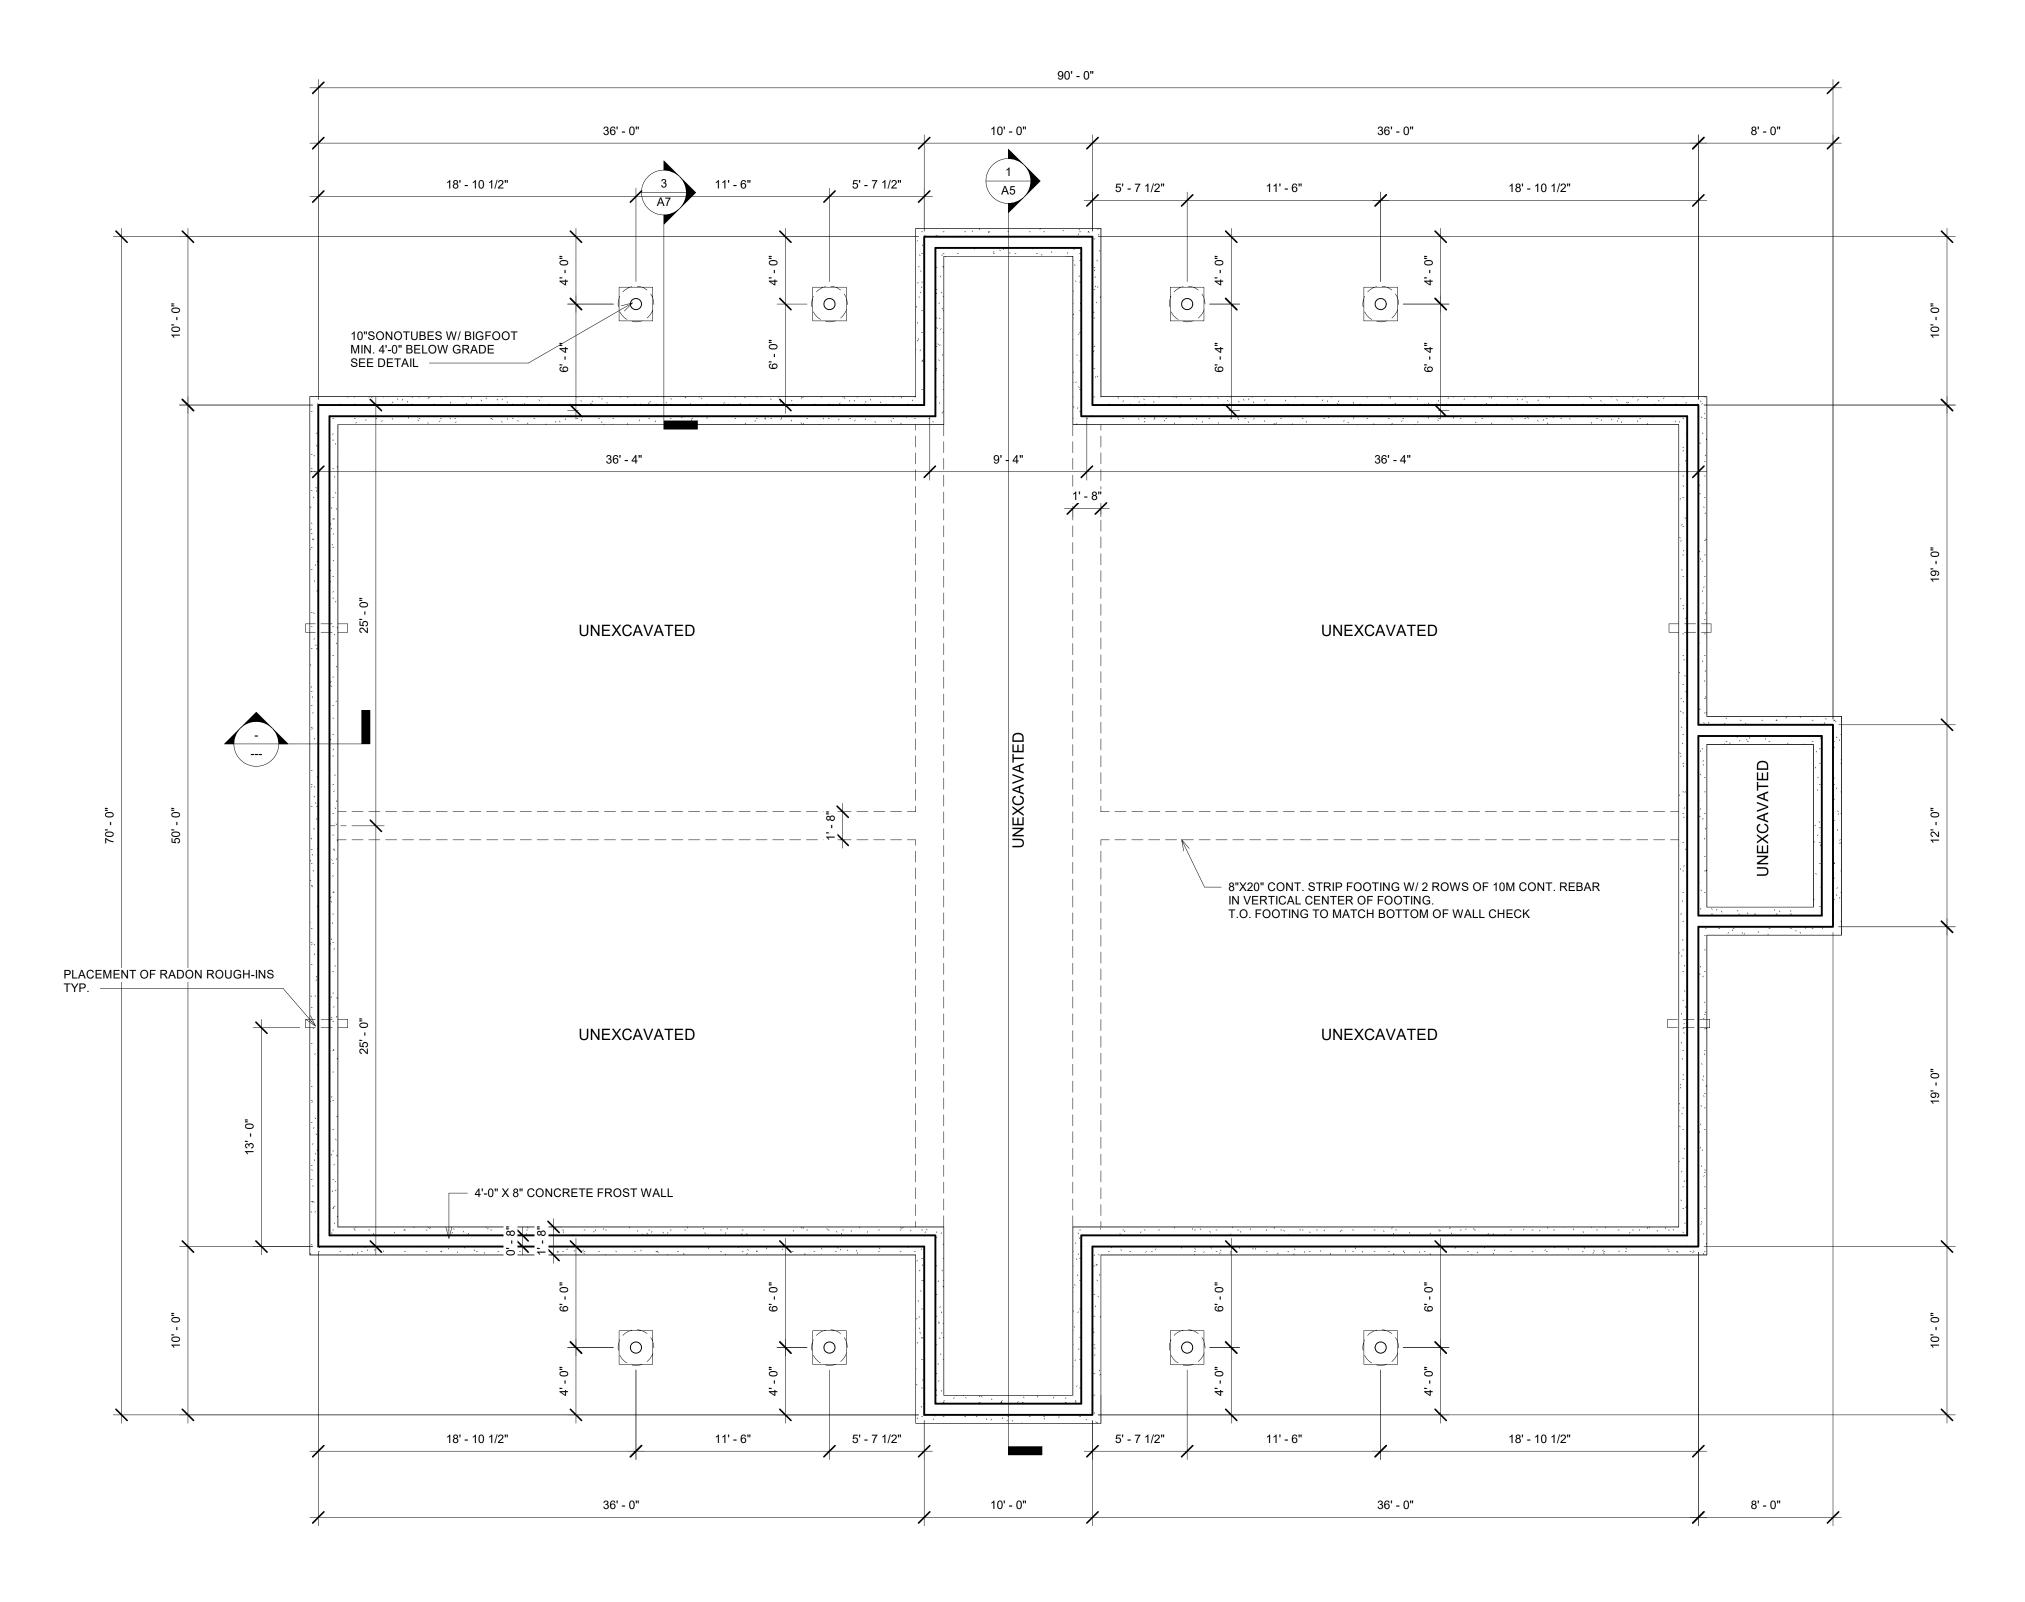


1 FOUNDATION PLAN
3/16" = 1'-0"

## FOR PERMIT


NO.1	INSULATION REVISED	21.11.2022
NO.	DESCRIPTION:	DATE:
REVISIO	ONS	






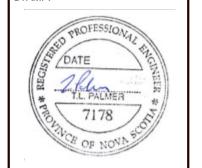

PROJECT:  KENTFIE	ELDS ESTA	TES - 8 UN	IIT	S1
TITLE: FOUNDATION	ON PLAN		,	ISSUE:
SCALE: AS NOTED	DATE: 02-08-2022	DRAWN: B.M.S	CHECKED:	JOB NO. 220102

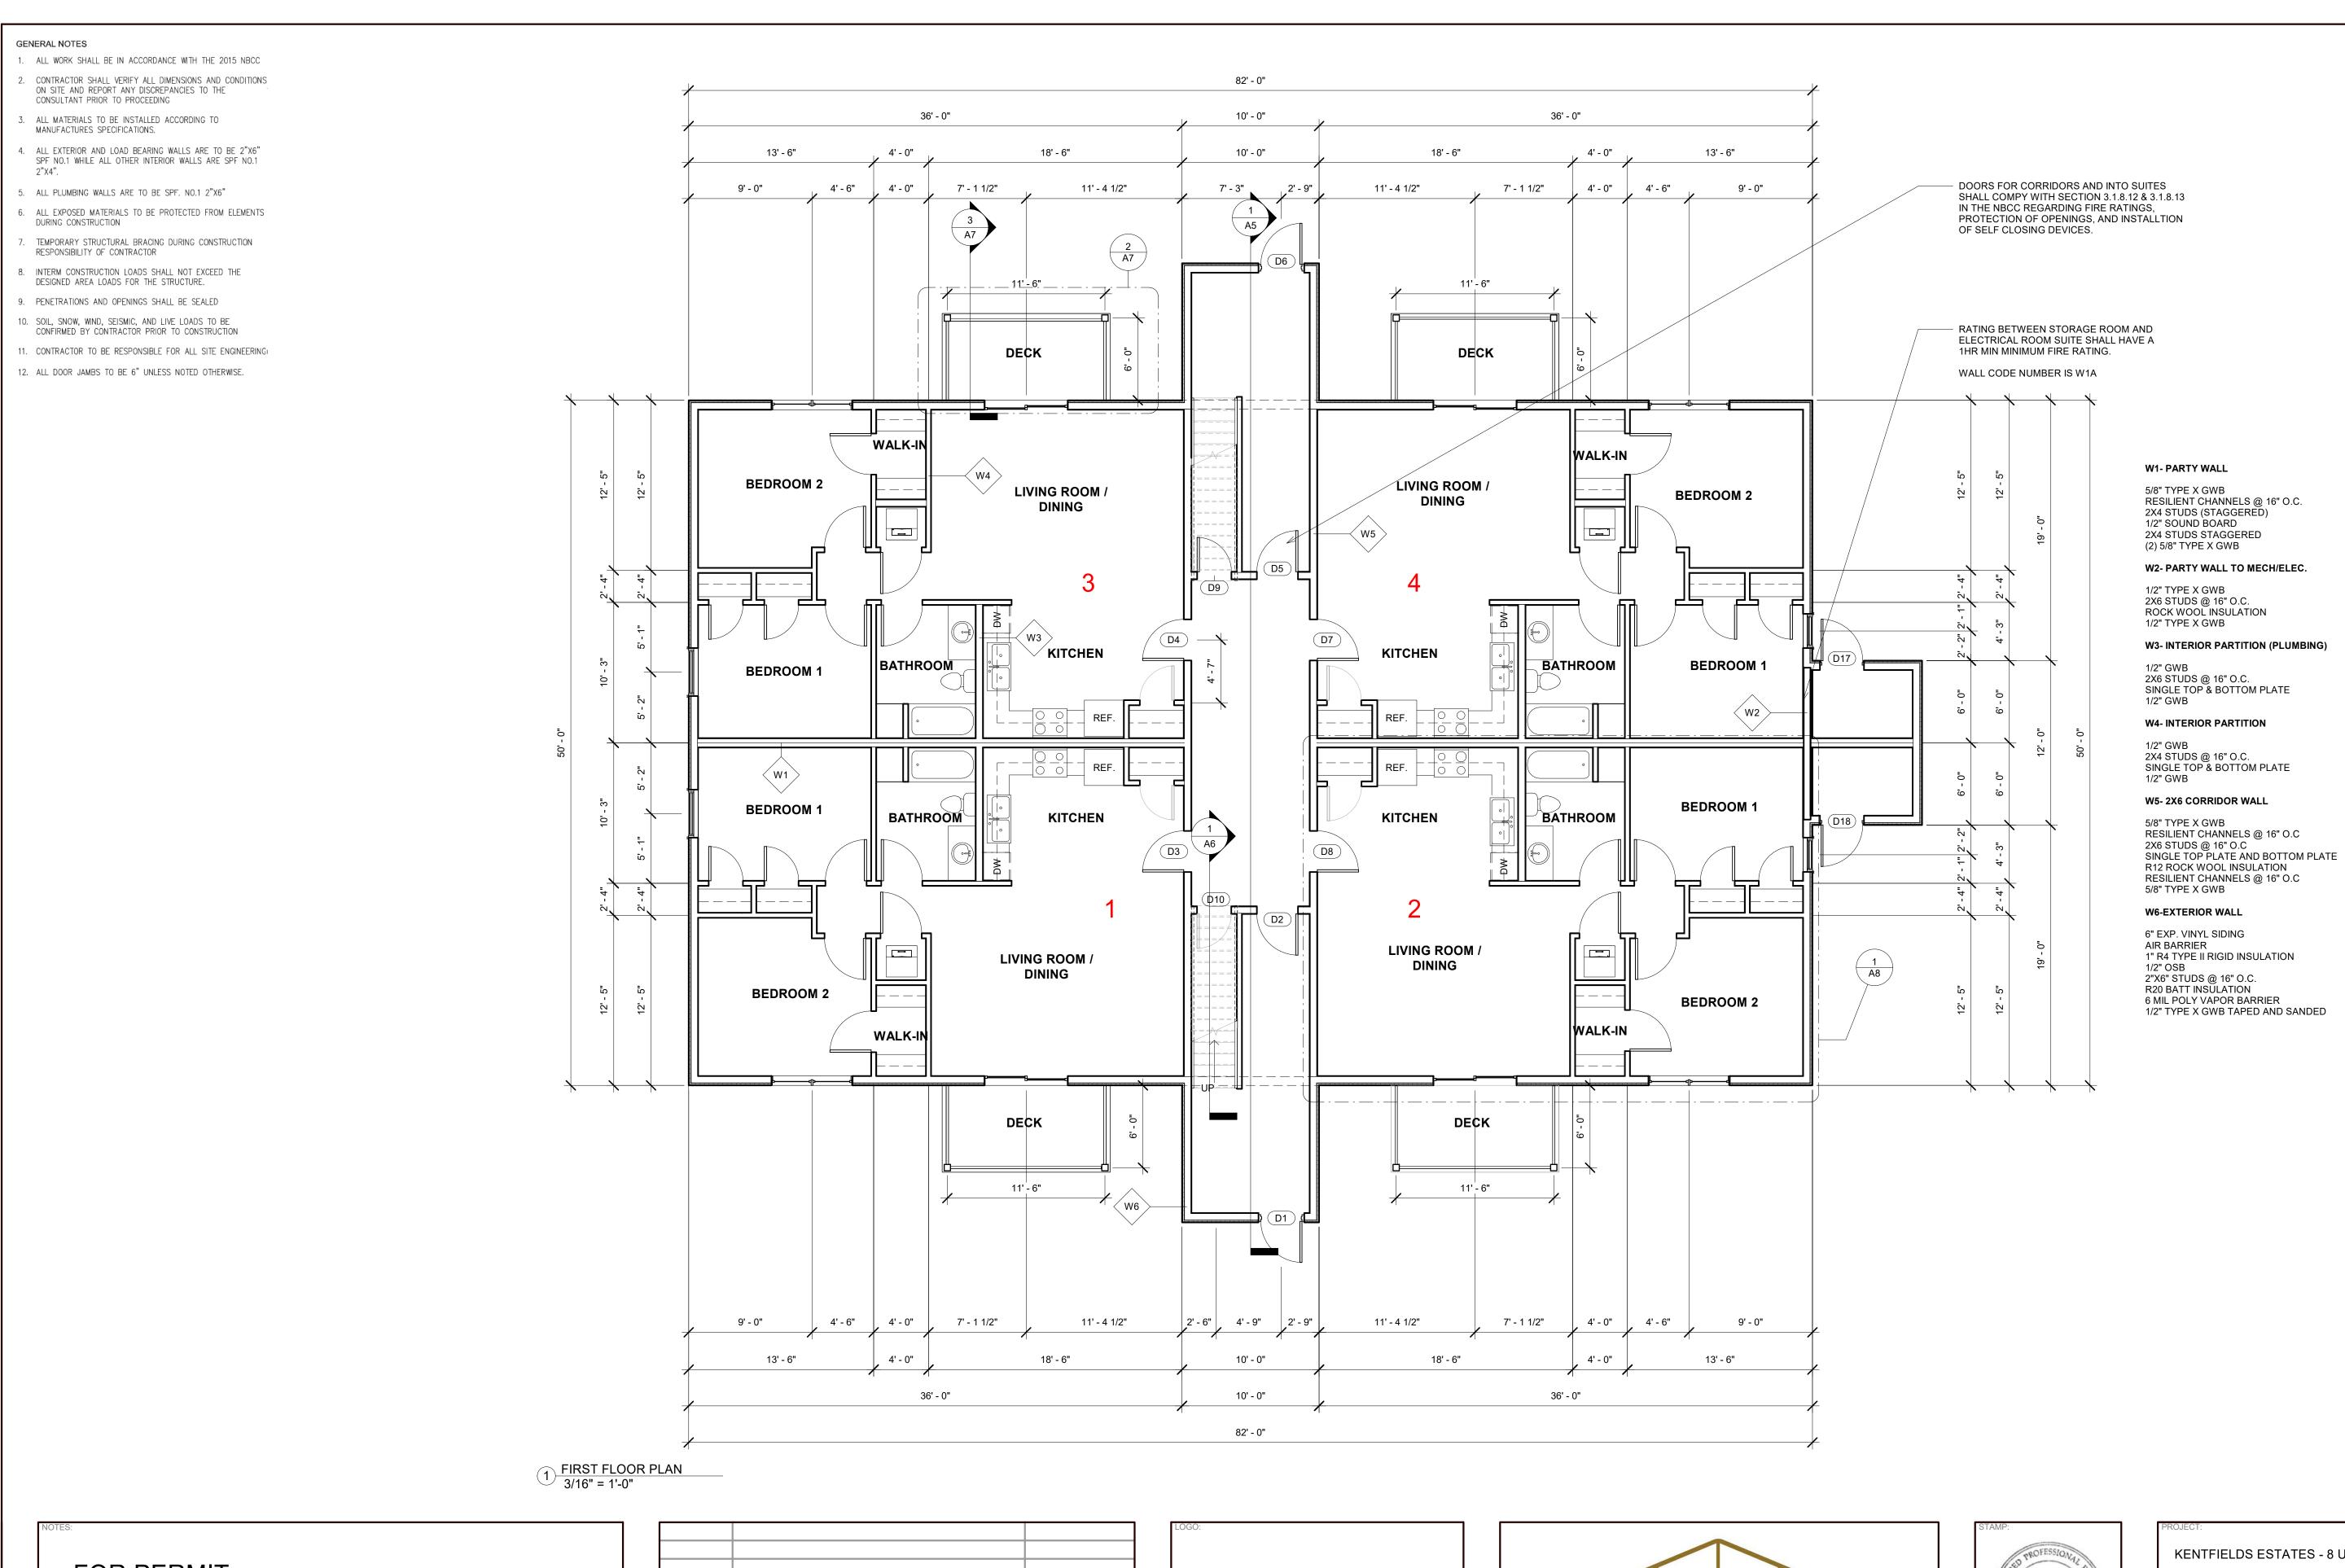

### **FOR PERMIT**

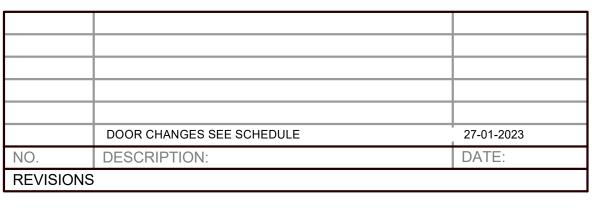








PROJECT:				DWG.
KENTFIE	ELDS ESTAT	ΓES - 8 UNI	Т	A1
TITLE:		-	-	ISSUE:
FIRST FLO				A
SCALE:	DATE:	DRAWN:	CHECKED:	JOB NO.
AS NOTED	02-08-2022	B.M.S	T.P.	220102

- 1. ALL WORK SHALL BE IN ACCORDANCE WITH THE 2015 NBCC
- CONTRACTOR SHALL VERIFY ALL DIMENSIONS AND CONDITIONS
   ON SITE AND REPORT ANY DISCREPANCIES TO THE
   CONSULTANT PRIOR TO PROCEEDING
- ALL MATERIALS TO BE INSTALLED ACCORDING TO MANUFACTURES SPECIFICATIONS.
- 4. ALL EXTERIOR AND LOAD BEARING WALLS ARE TO BE 2"X6" SPF NO.1 WHILE ALL OTHER INTERIOR WALLS ARE SPF NO.1
- 5. ALL PLUMBING WALLS ARE TO BE SPF. NO.1 2"X6"
- 6. ALL EXPOSED MATERIALS TO BE PROTECTED FROM ELEMENTS DURING CONSTRUCTION
- TEMPORARY STRUCTURAL BRACING DURING CONSTRUCTION RESPONSIBILITY OF CONTRACTOR
- 8. INTERM CONSTRUCTION LOADS SHALL NOT EXCEED THE DESIGNED AREA LOADS FOR THE STRUCTURE.
- 9. PENETRATIONS AND OPENINGS SHALL BE SEALED
- 10. SOIL, SNOW, WIND, SEISMIC, AND LIVE LOADS TO BE CONFIRMED BY CONTRACTOR PRIOR TO CONSTRUCTION
- 11. CONTRACTOR TO BE RESPONSIBLE FOR ALL SITE ENGINEERING
- 12. ALL DOOR JAMBS TO BE 6" UNLESS NOTED OTHERWISE.

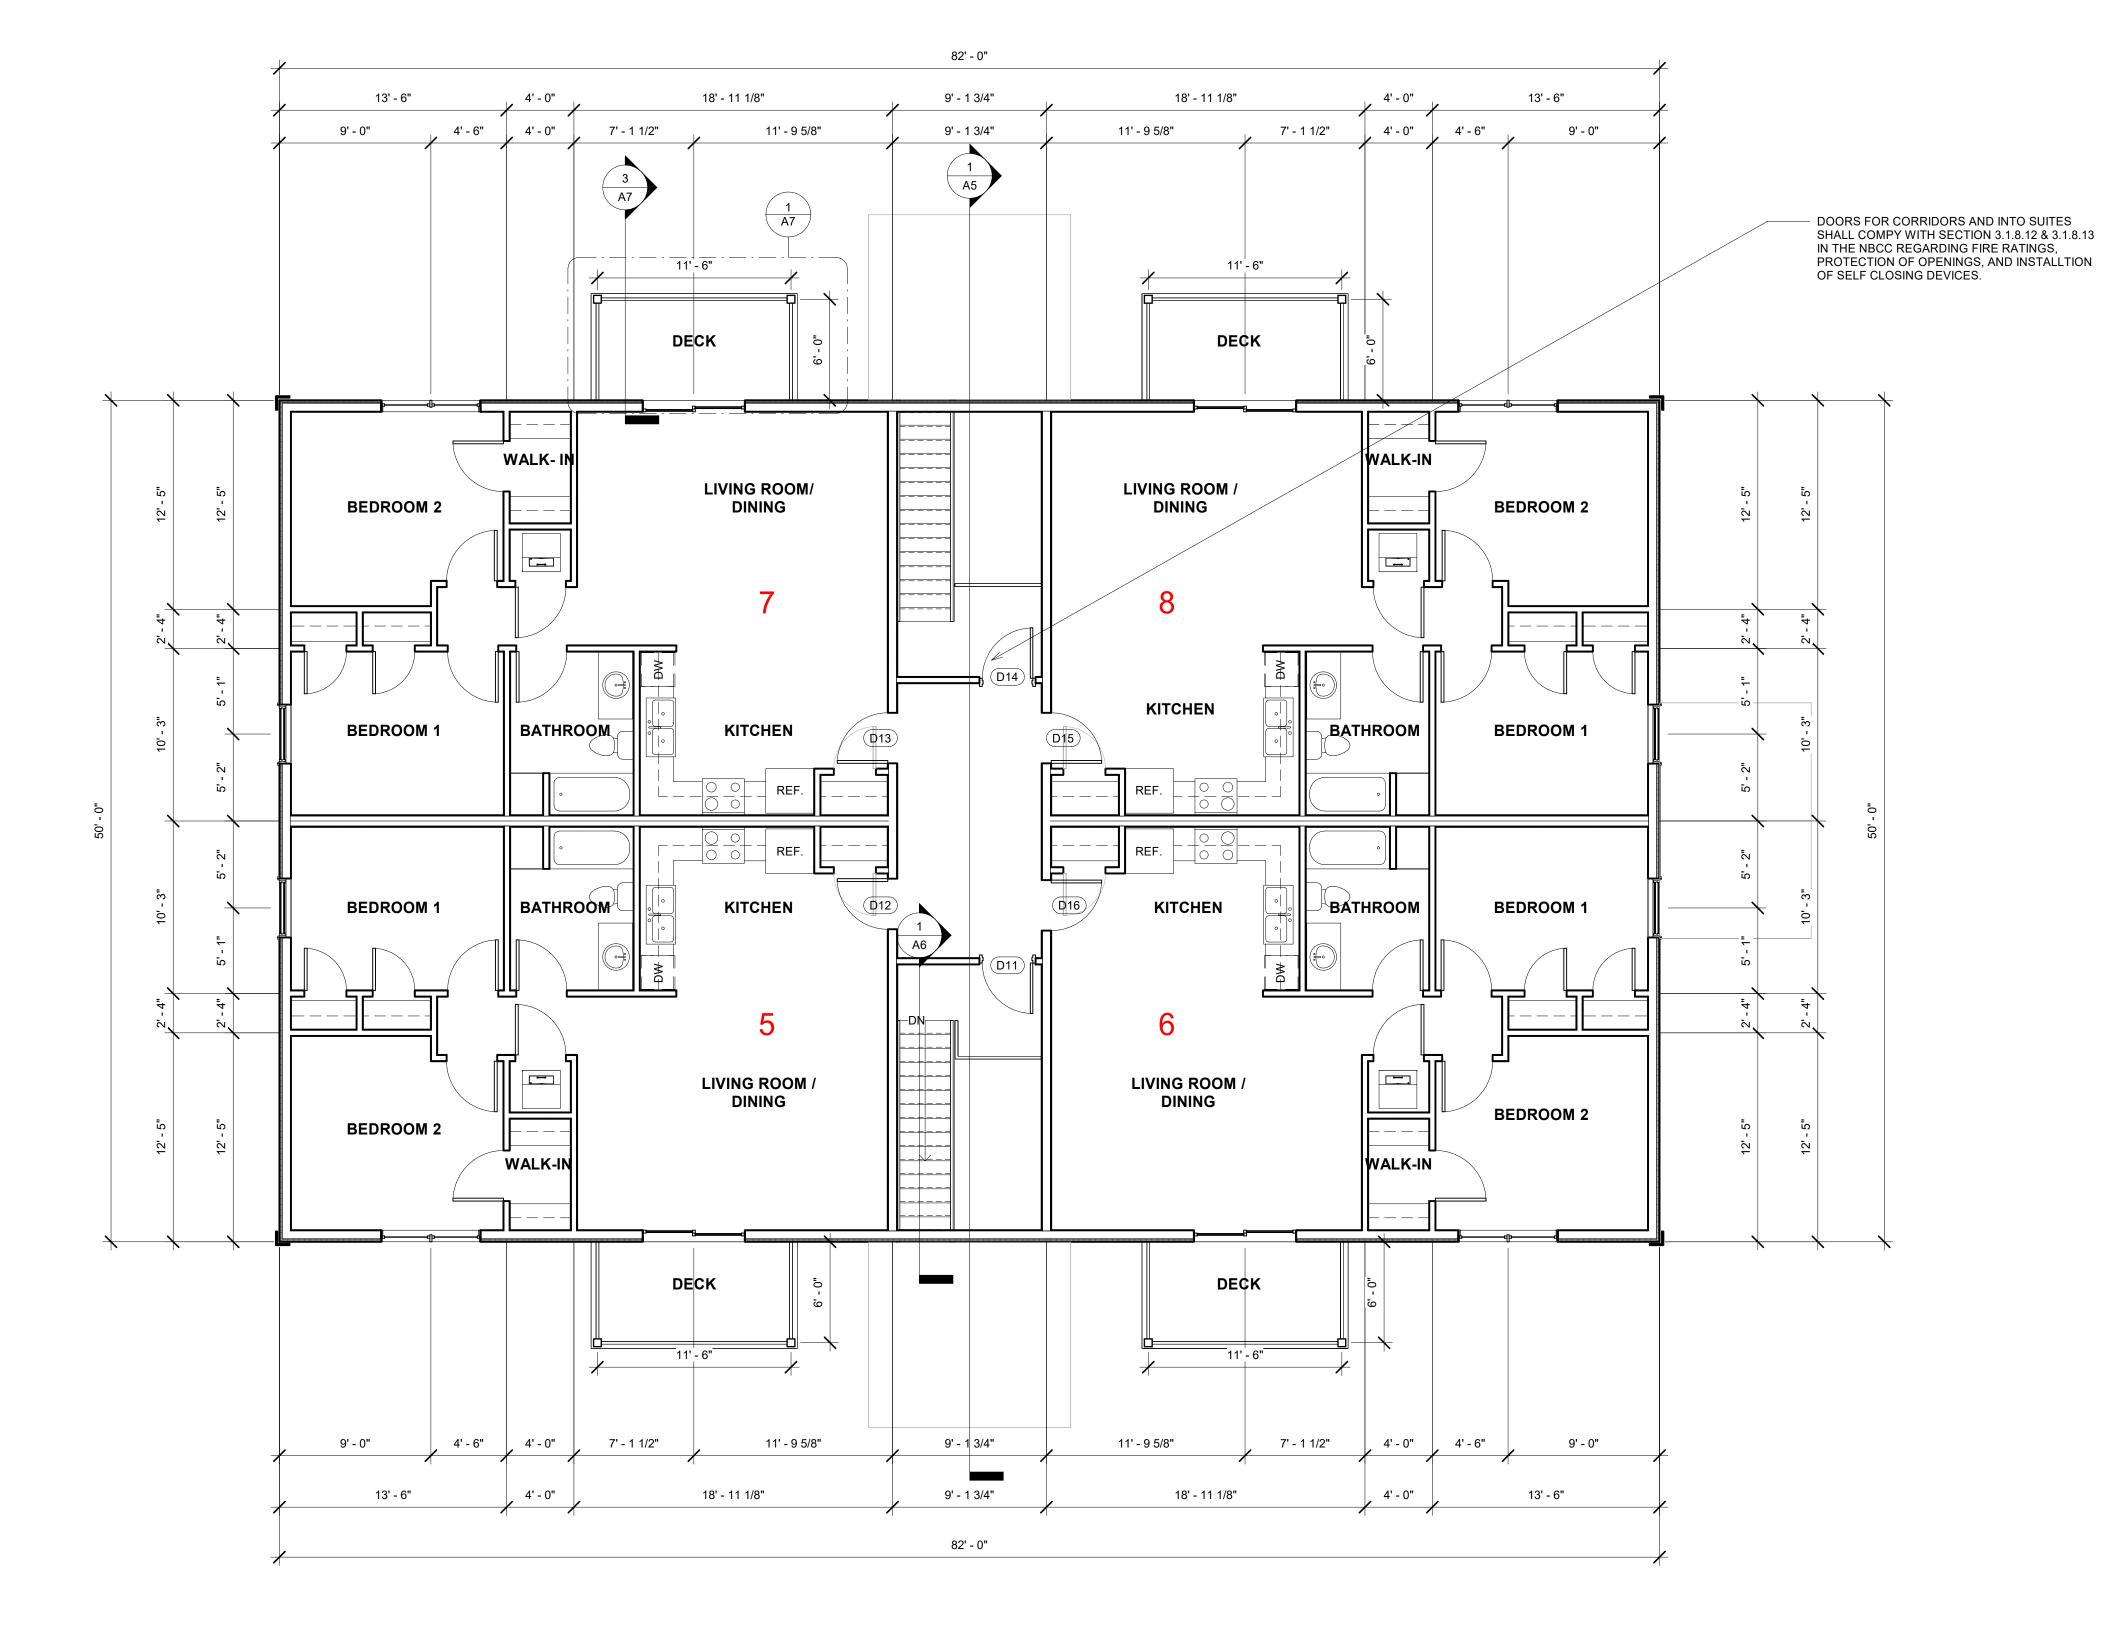

1 SECOND FLOOR PLAN 3/16" = 1'-0"

FOR PERMIT

	DOOR CHANGES SEE SCHEDULE	27-01-2023
NO.	DESCRIPTION:	DATE:
REVISION	S	









	ELDS ESTAT	ΓES - 8 UN	IIT	A2
TITLE: SECOND F	LOOR PLAN		,	ISSUE:
00415	DATE:	DRAWN:	CHECKED:	
SCALE:				JOB NO.






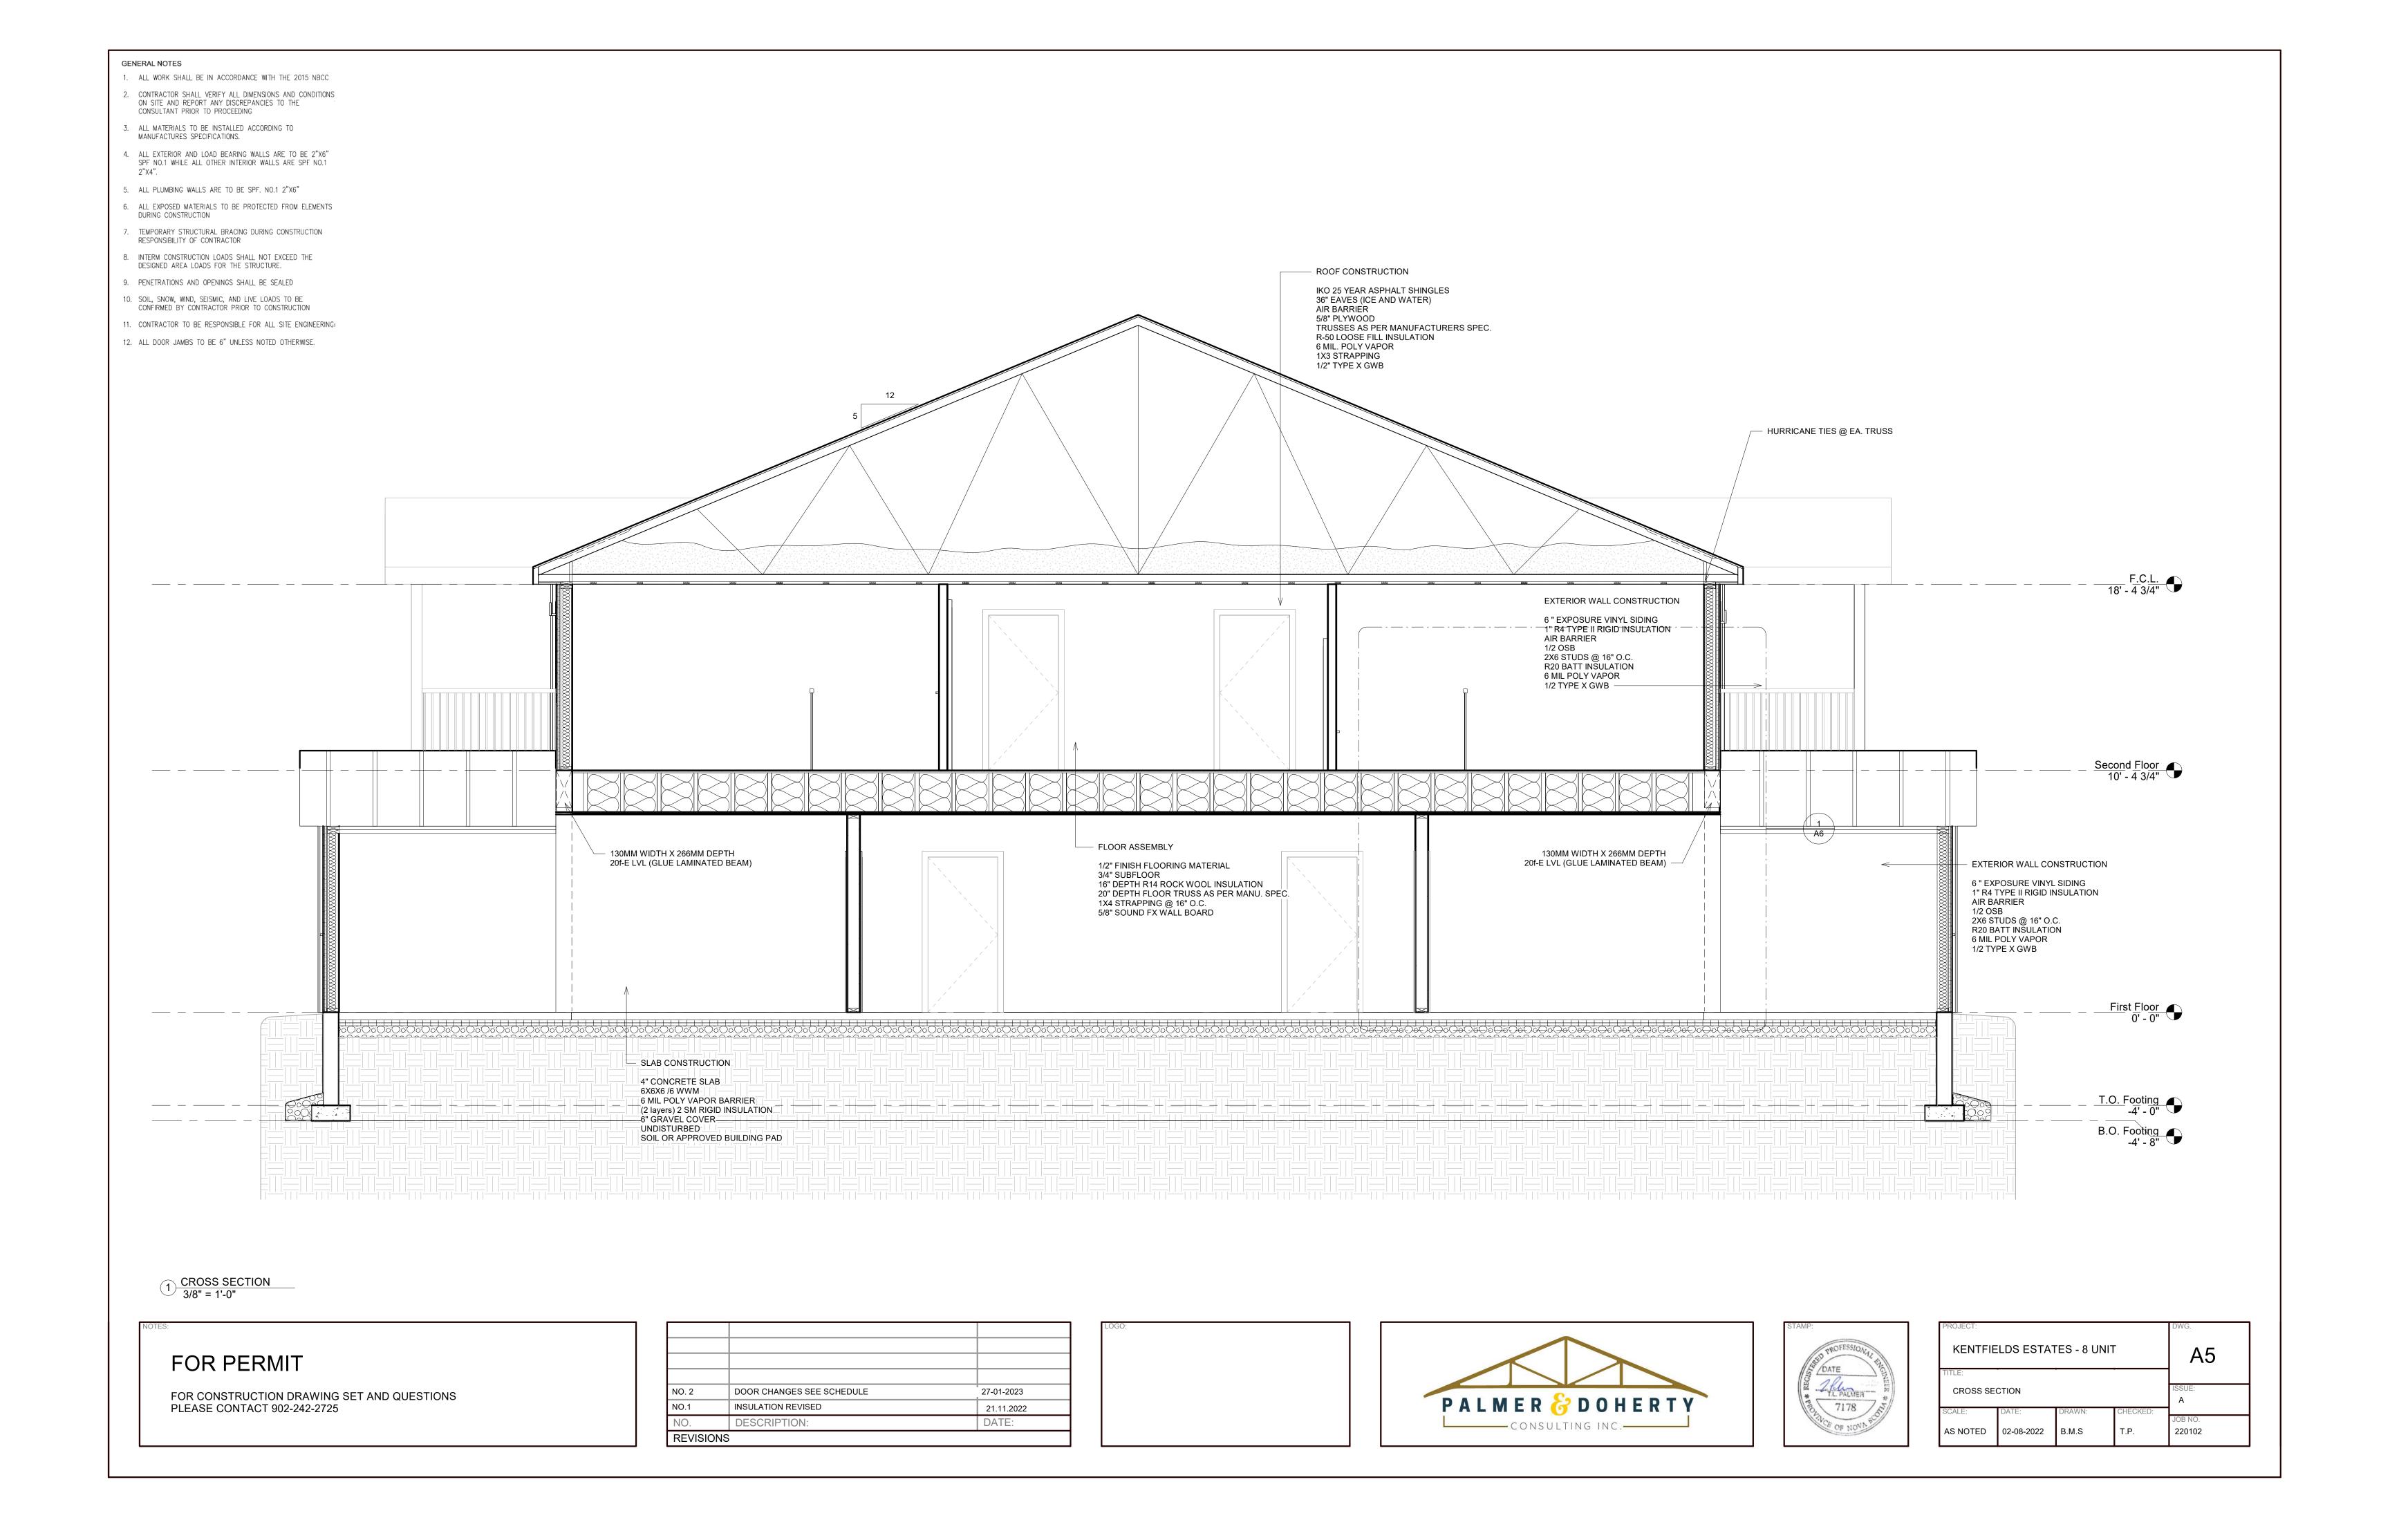

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- ALL EXTERIOR AND LOAD BEARING WALLS ARE TO BE 2"X6" SPF NO.1 WHILE ALL OTHER INTERIOR WALLS ARE SPF NO.1 2"X4".
- 5. ALL PLUMBING WALLS ARE TO BE SPF. NO.1 2"X6"
- 6. ALL EXPOSED MATERIALS TO BE PROTECTED FROM ELEMENTS DURING CONSTRUCTION
- 7. TEMPORARY STRUCTURAL BRACING DURING CONSTRUCTION RESPONSIBILITY OF CONTRACTOR
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1 STAIR SECTION 3/4" = 1'-0"
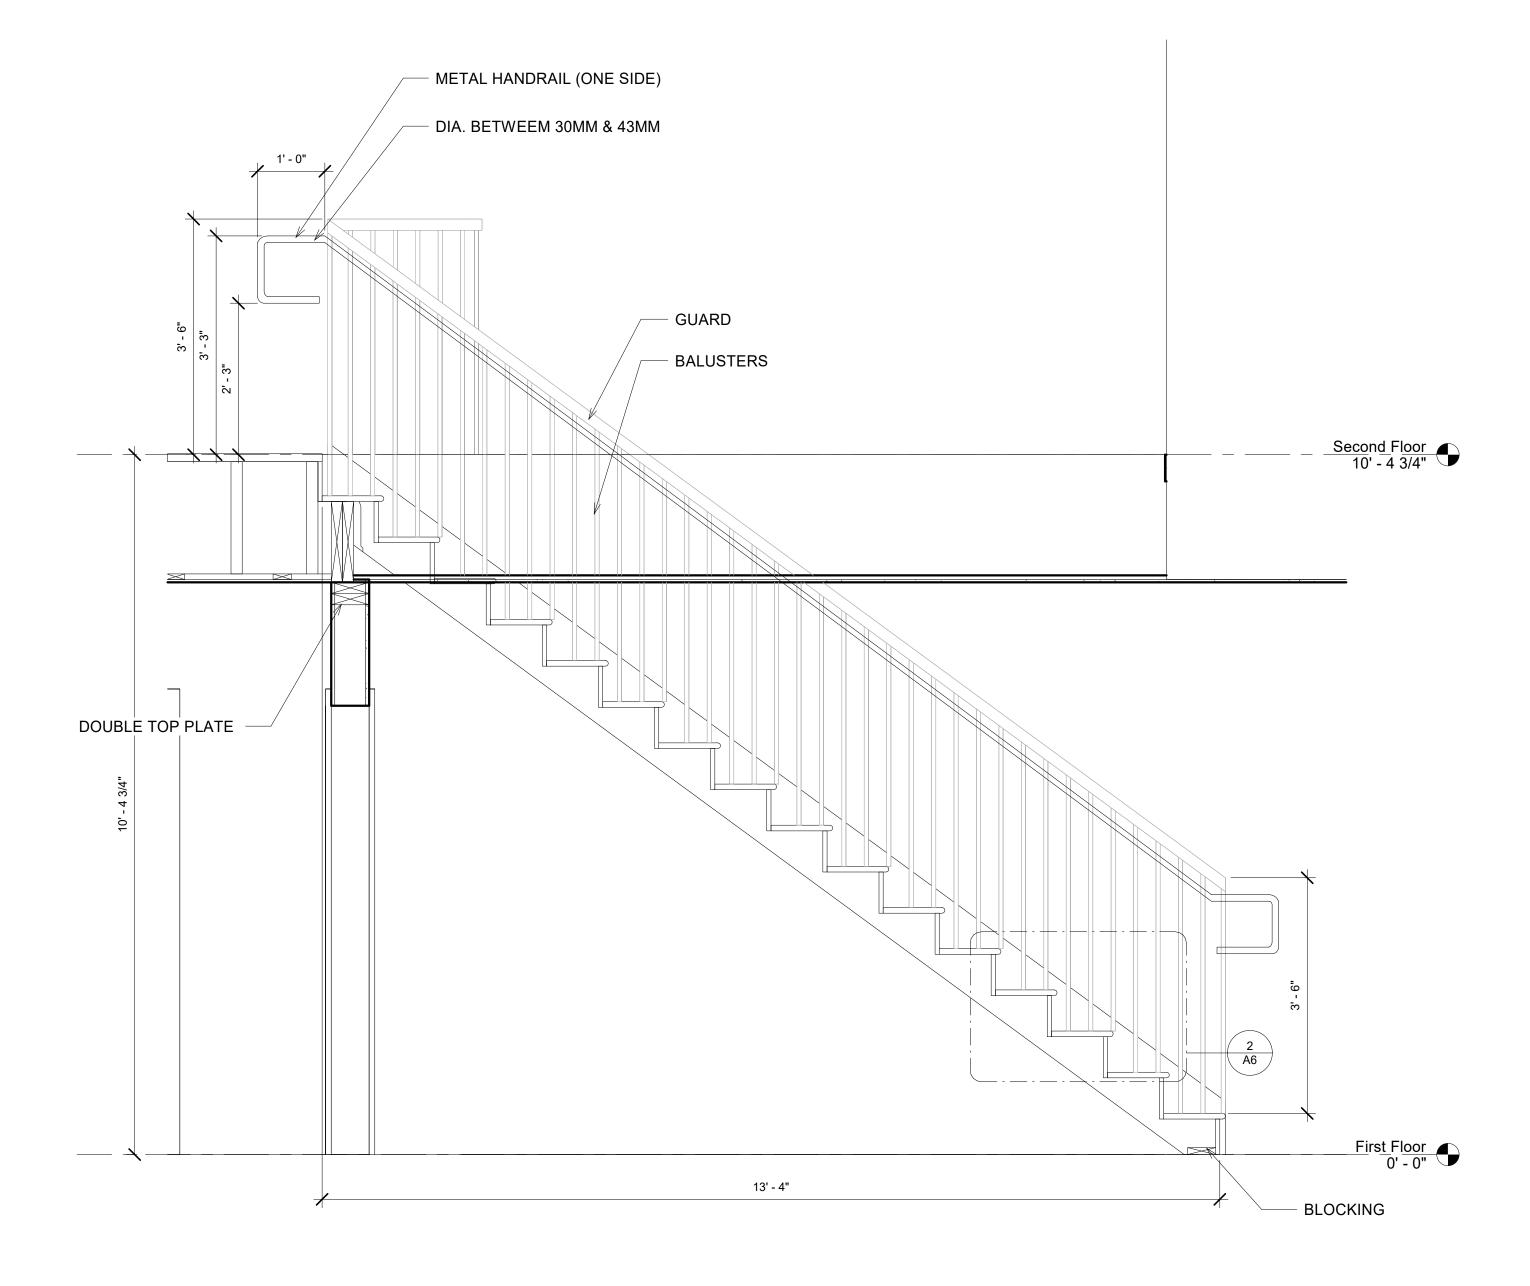
## FOR PERMIT

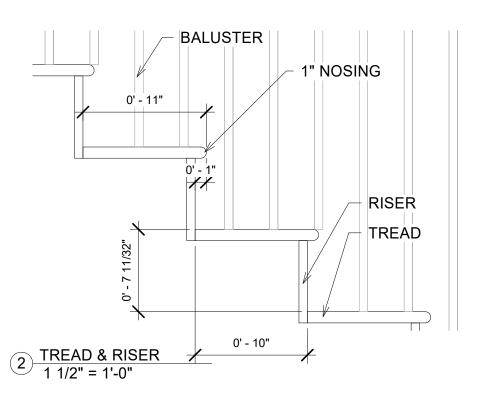	DOOR CHANGES SEE SCHEDULE	27-01-2023
NO.	DESCRIPTION:	DATE:
REVISIO	NS	









PROJECT: KENTFIELDS ESTATES - 8 UNIT				A6
TITLE: STAIR CON:	STRUCTION			ISSUE: A
SCALE: AS NOTED	DATE: 29-08-2022	DRAWN: B.M.S	CHECKED: T.P.	JOB NO. 220102


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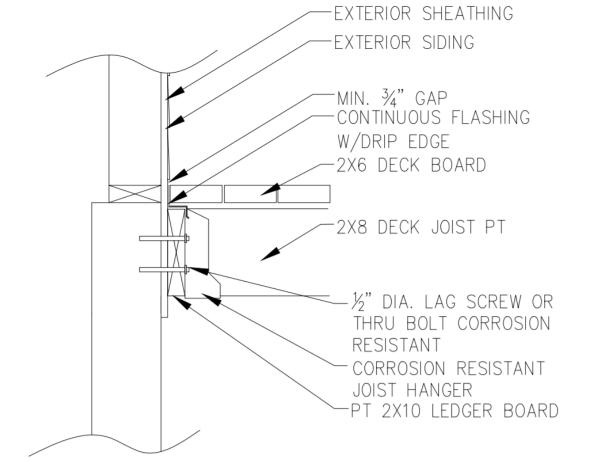


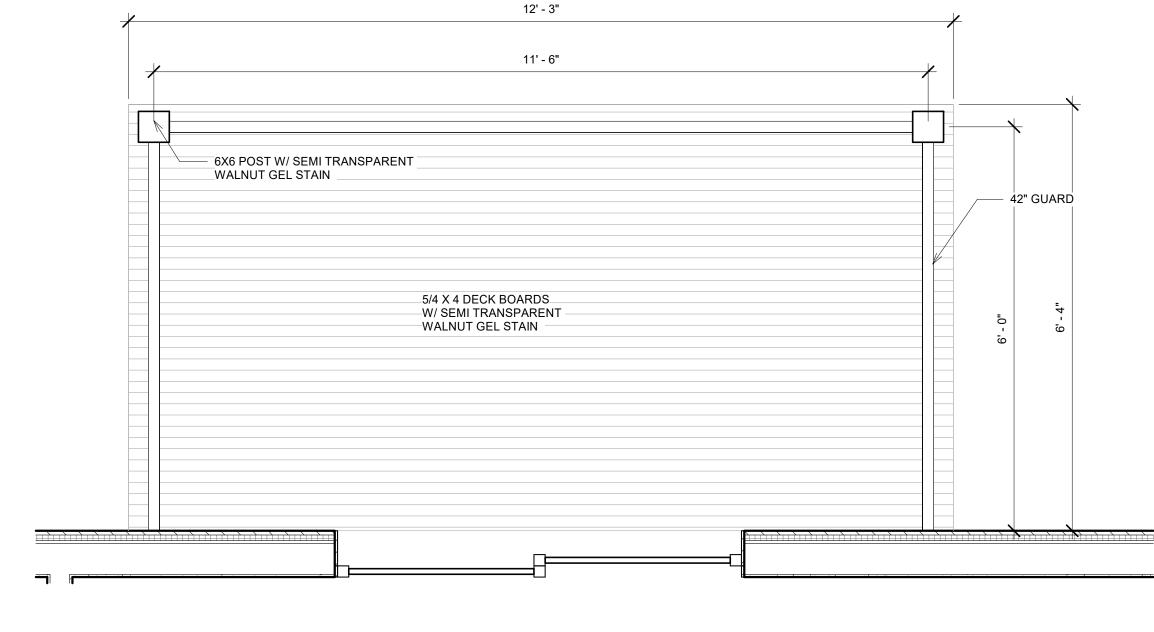


1 DECK PLAN VIEW 3/4" = 1'-0"



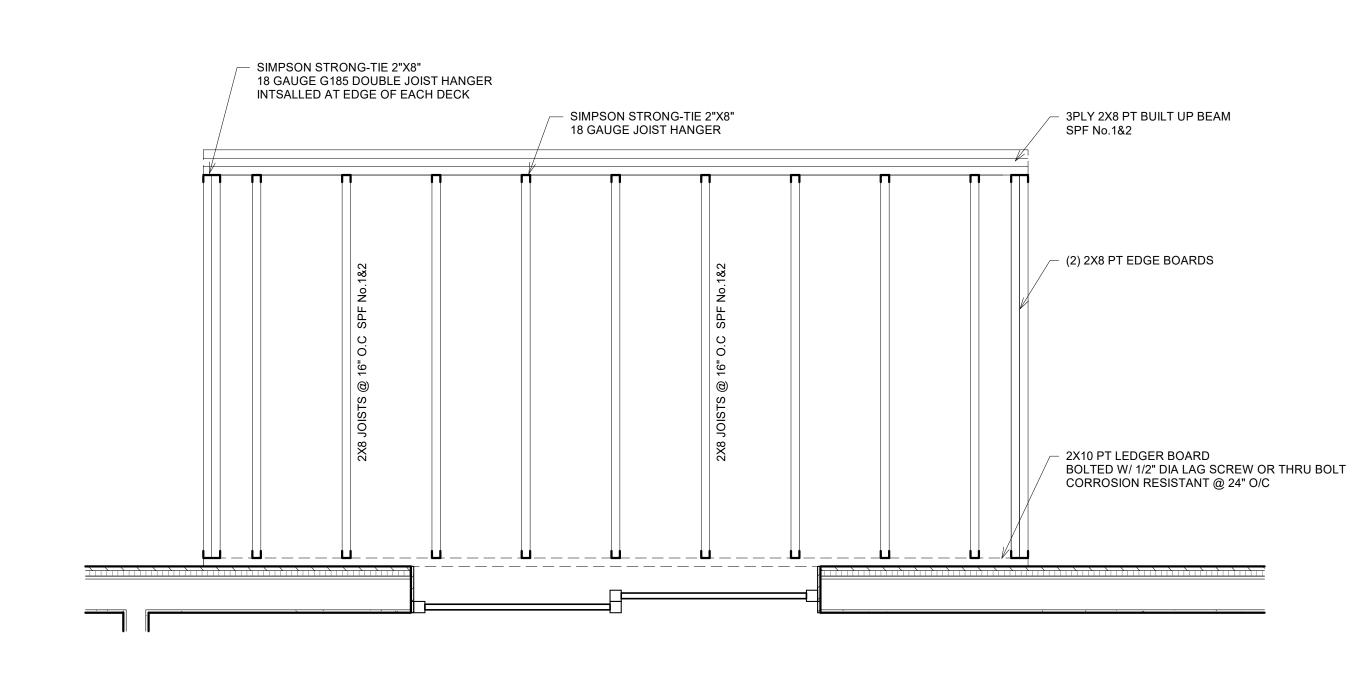

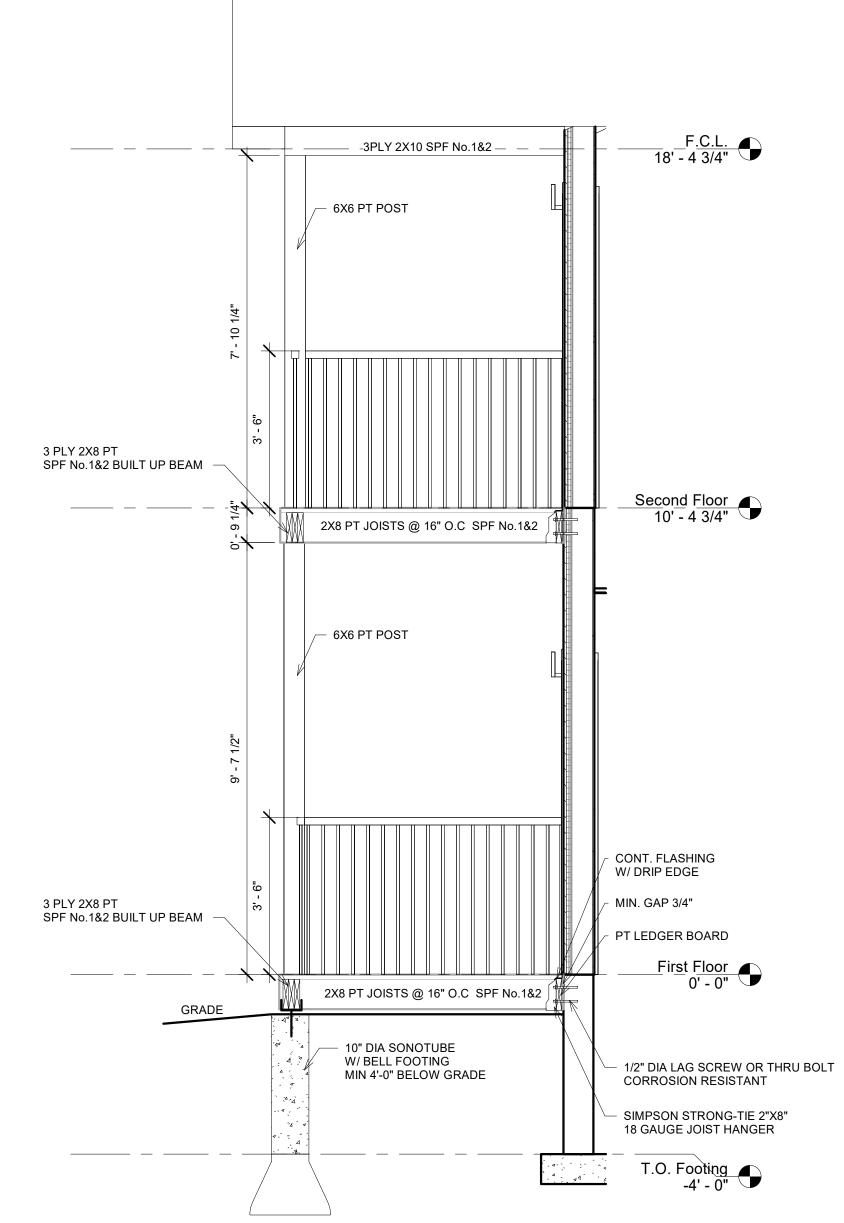

2 DECK FLOOR FRAMING 3/4" = 1'-0"

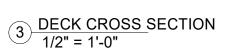

### FOR PERMIT


	DOOR CHANGES SEE SCHEDULE	27-01-2023
NO.	DESCRIPTION:	DATE:
REVISIO	DNS	









PROJECT:				DWG.	1
KENTFIE	A7				
DECK CON	ISSUE:	$\frac{1}{1}$			
SCALE: AS NOTED	DATE: 16-08-2022	DRAWN: B.M.S	CHECKED:	JOB NO. 220102	

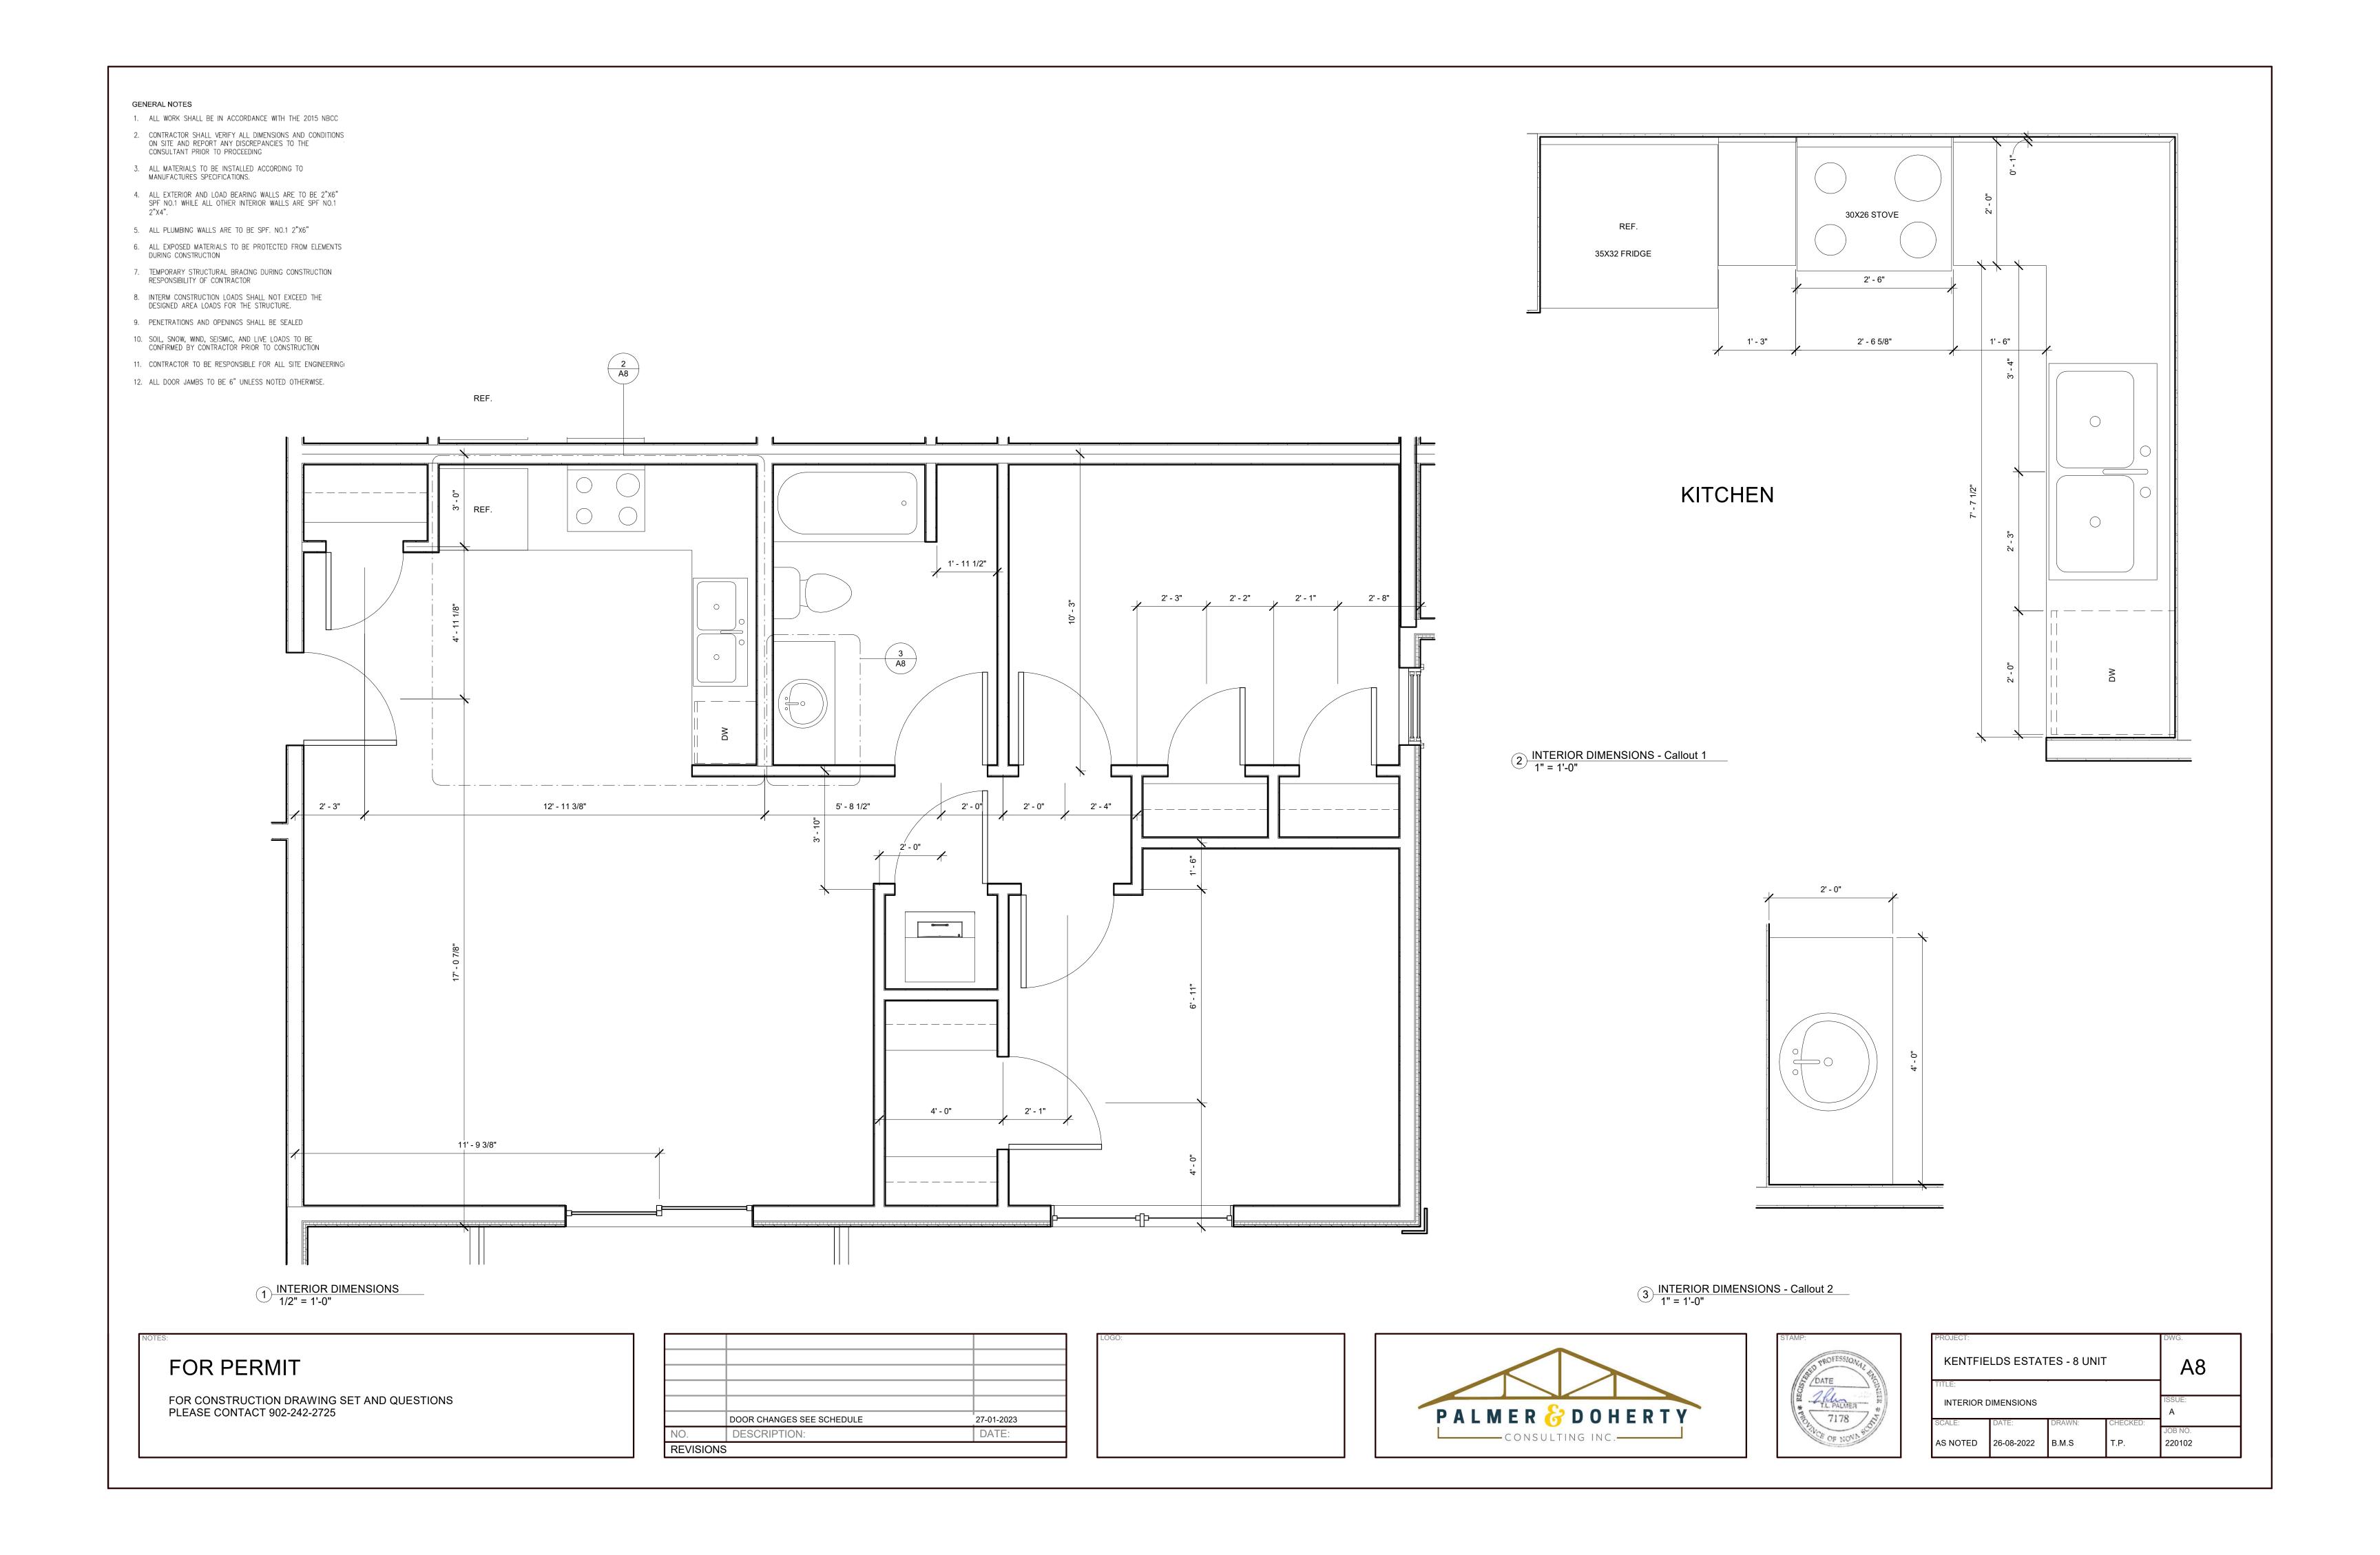

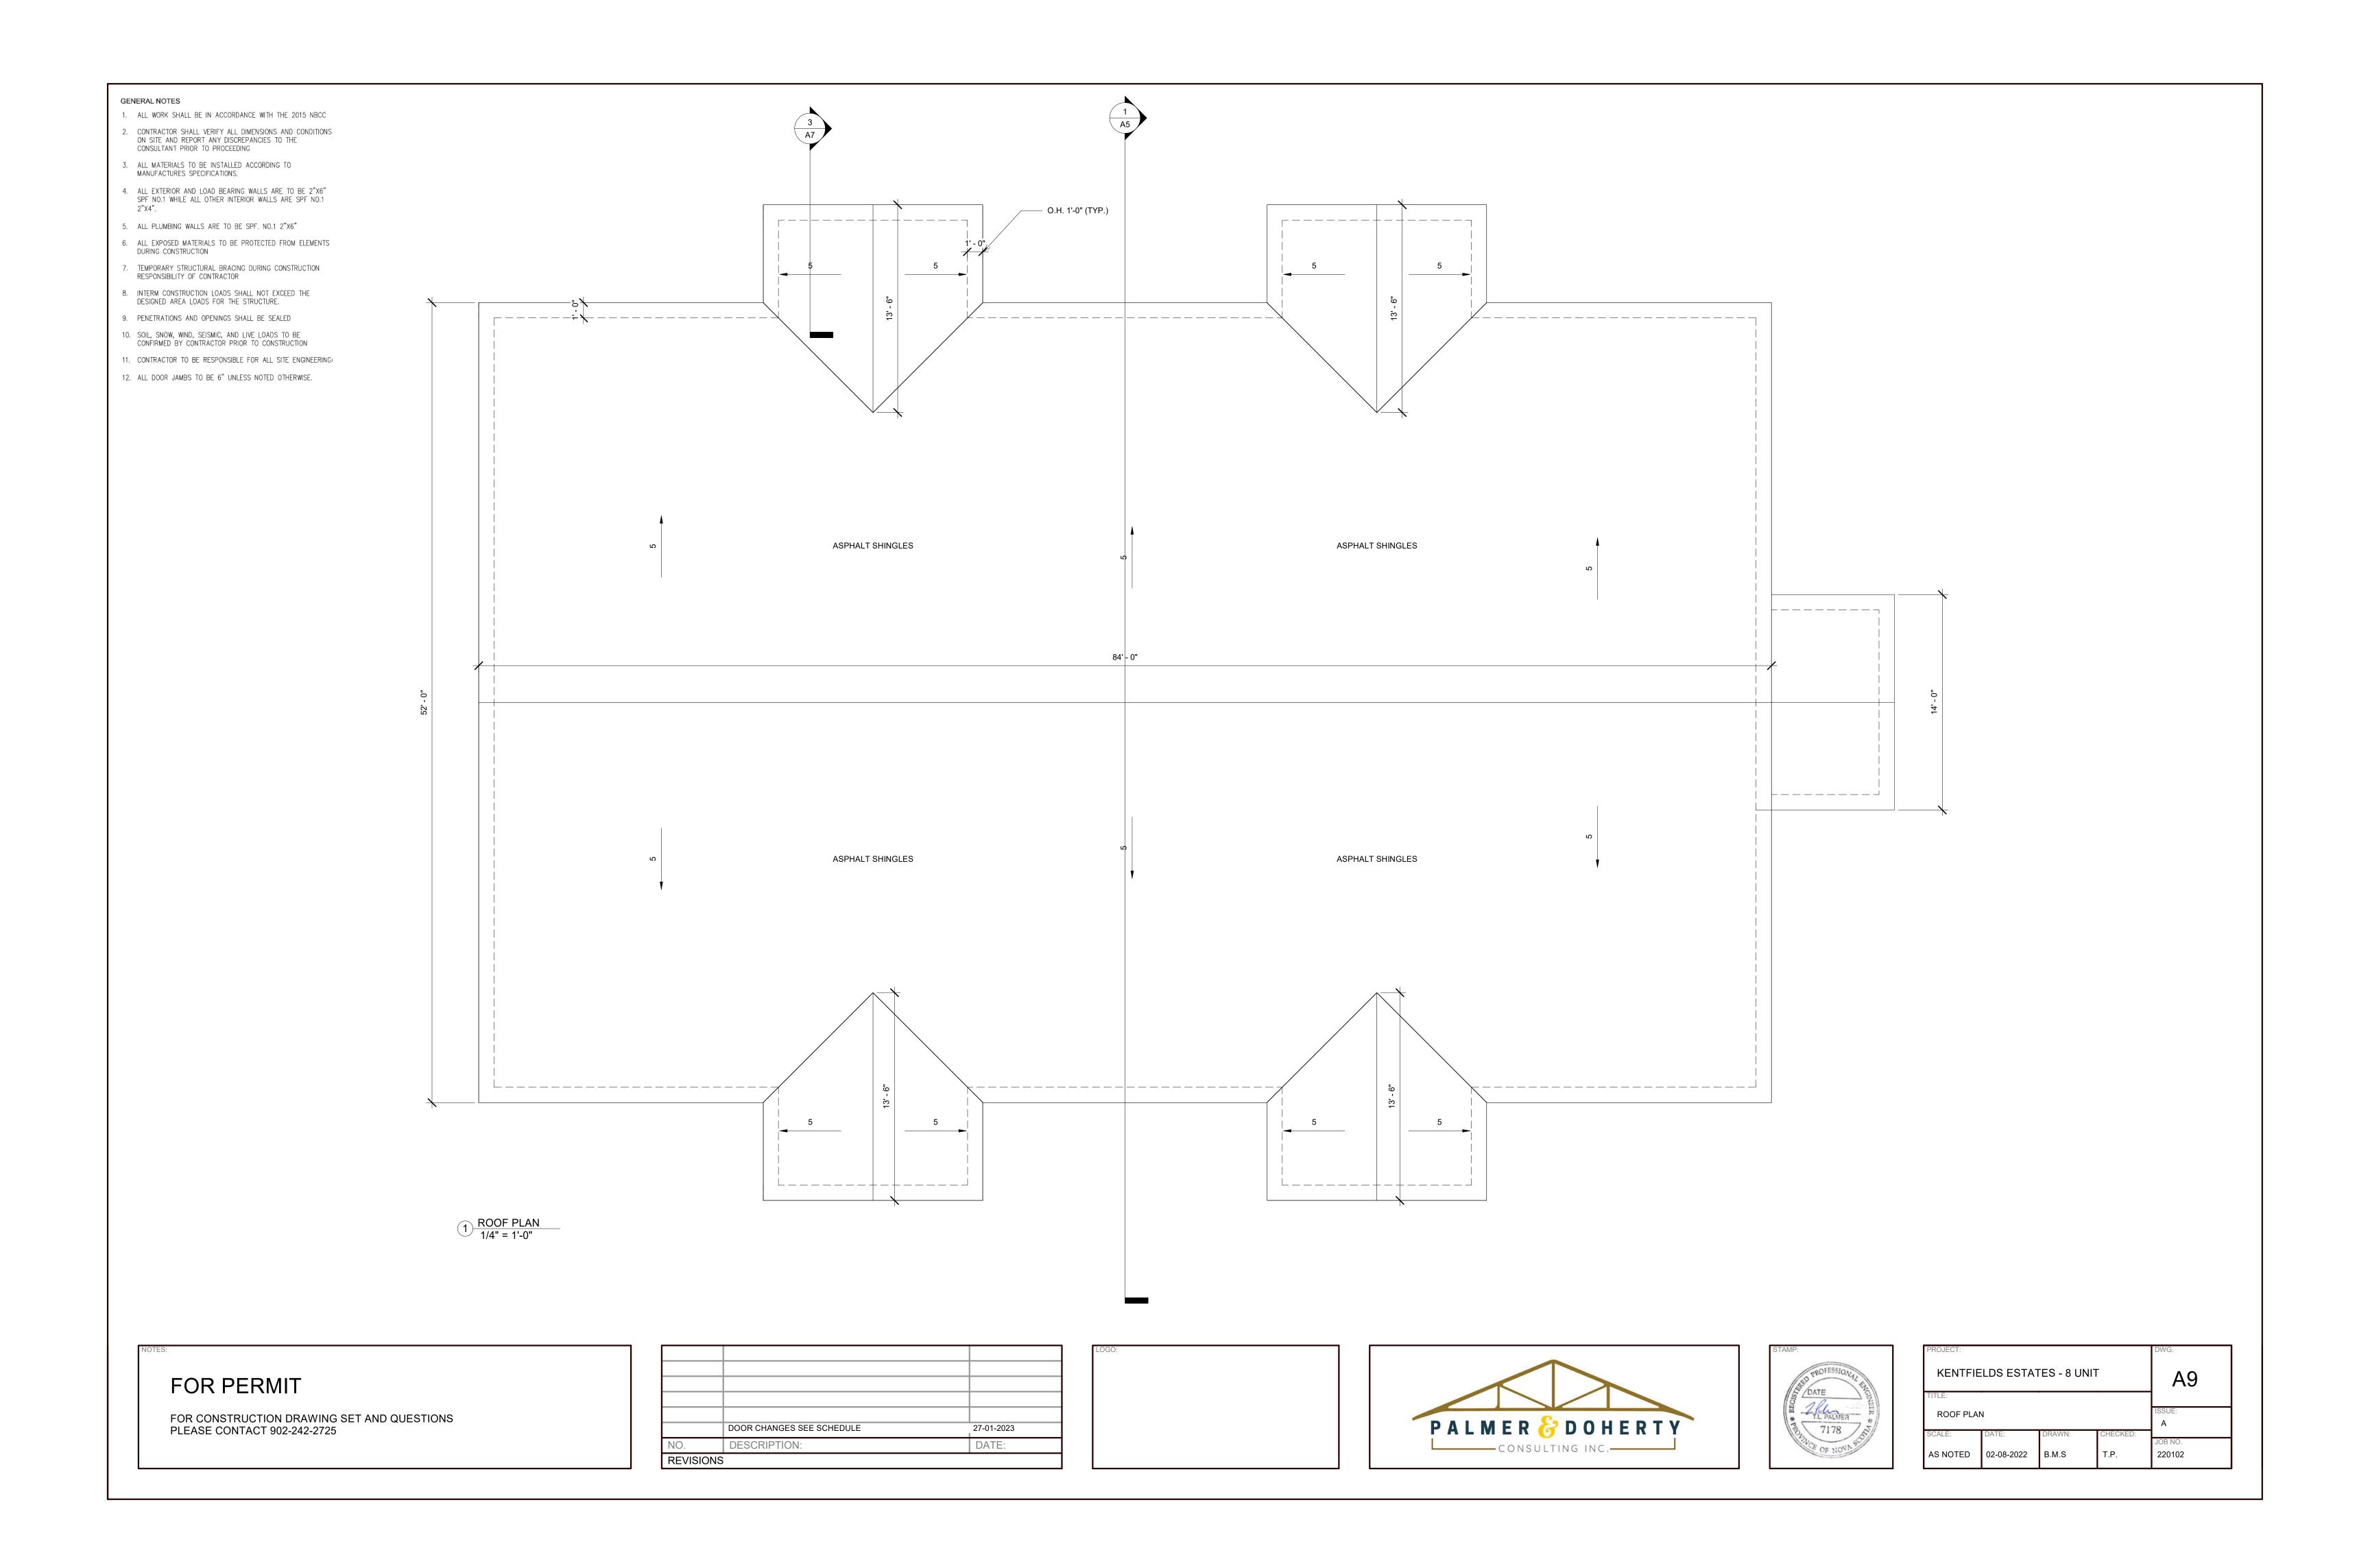

## **WINDOW SCHEDULE**

SYM IDENT.	TYPE	ROUGH OPENING	SILL HEIGHT	QUANTITY	MODEL#	NOTES
W1	SINGLE UNIT DOUBLE	60" X 72"	2'-2 ¾"	8		LOW-E, ARGON FILLED 2X2 GRID
W2	FIXED	30" X 30"	4'-7 1/4"	2		LOW-E, ARGON FILLED
W3	SINGLE HUNG	48" X 30"	3'-0"	2		LOW-E, ARGON FILLED 2X2 GRID
W4	SINGLE HUNG	57" X42"	3'-0"	6		LOW-E, ARGON FILLED 2X2 GRID

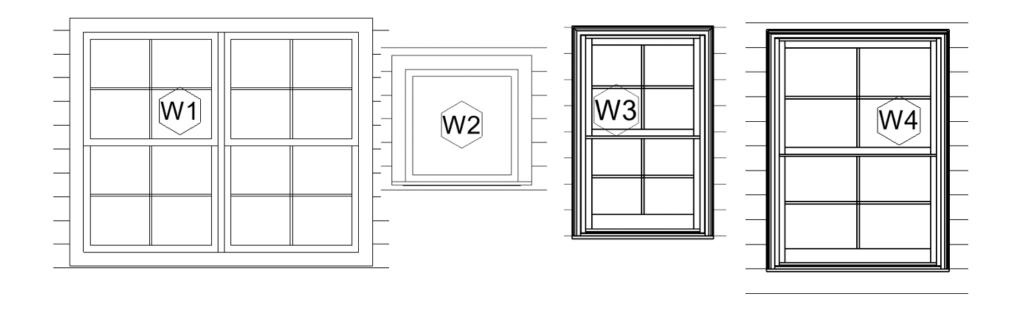

## FIRST FLOOR COORIDOR - DOOR SCHEDULE

SYM. IDENT.	SIZE	STYLE	MODEL#	TYPE	SWING	NOTES
D1	36"X 80"	INSULATED ENRTY DOOR		Α	RHR	½ LITE
D2	36"X80"	MAN DOOR- INTERIOR CORRIDOR		В	RHR	20 MIN FIRE RATED, ½ LITE
D3	36"X80"	MAN DOOR		С	LH	20 MIN FIRE RATED
D4	36"X80"	MAN DOOR		С	LH	20 MIN FIRE RATED
D5	36"X80"	MAN DOOR- INTERIOR CORRIDOR		В	LHR	20 MIN FIRE RATED, ½ LITE
D6	36"X80"	INSULATED ENRTY DOOR		Α	LHR	½ LITE
D7	36"X80"	MAN DOOR		С	RH	20 MIN FIRE RATED
D8	36"X80"	MAN DOOR		С	RH	20 MIN FIRE RATED
D9	30"X80"	STORAGE		D	LH	NOT PUBLIC- STORAGE
D10	30"X80"	STORAGE		D	RH	NOT PUBLIC- STORAGE

## SECOND FLOOR COORIDOR - DOOR SCHEDULE

SYM. IDENT.	SIZE	STYLE	MODEL#	TYPE	SWING	NOTES
D11	36"X80"	MAN DOOR- INTERIOR CORRIDOR		В	RHR	20 MIN FIRE RATED, ½ LITE
D12	36"X80"	MAN DOOR		С	RH	20 MIN FIRE RATED, ½ LITE
D13	36"X80"	MAN DOOR		С	LH	20 MIN FIRE RATED, ½ LITE
D14	36"X80"	MAN DOOR- INTERIOR CORRIDOR		В	RHR	20 MIN FIRE RATED, ½ LITE
D15	36"X80"	MAN DOOR		С	LH	20 MIN FIRE RATED, ½ LITE
D16	36"X80"	MAN DOOR		С	RH	20 MIN FIRE RATED. ½ LITE

### **MECHANICAL ROOM**

SYM. IDENT.	SIZE	STYLE	TYPE	SWING
D17	36"x80"	EXTERIOR STEEL	Н	RHR
D18	36"X80"	EXTERIOR STEEL	Н	LHR

## **UNITS 1&3**

SIZE	STYLE	TYPE	QUANTITY
36"x80"	INTERIOR DOOR	E	<del>-6-</del> 5
30"X80"	INTERIOR DOOR	F	3
72"X84"	SLIDING PATIO	G	1

## UNITS 2,4,5,6,7 & 8

SIZE	STYLE	TYPE	QUANTITY
36"x80"	INTERIOR DOOR	E	5
30"X80"	INTERIOR DOOR	F	3
72"X84"	SLIDING PATIO	G	1

FOR PERMIT

		_
	DOOR CHANGES SEE SCHEDULE	27-01-2023
NO.	DESCRIPTION:	DATE:
REVISIONS	3	









PROJECT:				DWG.
KENTFIE	A 10			
				_ A10
TITLE:				
SCHEDUL	ISSUE:			
SCALE:	DATE:	DRAWN:	CHECKED:	A
				JOB NO.
AS NOTED	29-08-2022	B.M.S	T.P.	220102




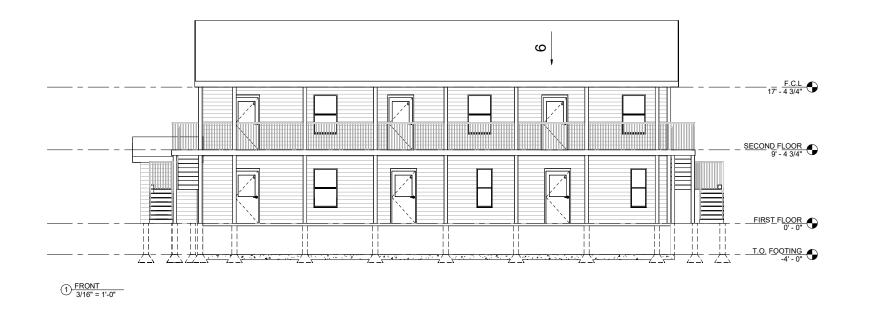

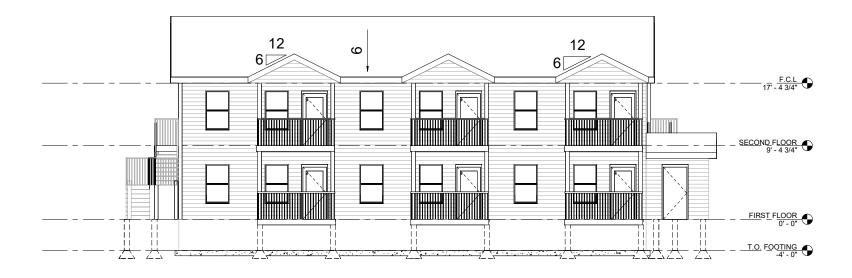

2 BACK 3/16" = 1'-0"



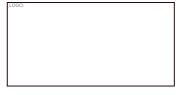





6 UNIT KENT FEILD ESTATES TILLE: ELEVATIONS				A-2
AS NOTED	07-05-2024	км	N/A	JOB NO.

